

LOCATION MAP

RENSSELAER ALBANY SCHOHARIE PROJECT. GREENE LOCATION ĆATSKILL COLUMBIA , KINGSTON/ ULSTER **DUTCHESS** PENNSYLVANIA NEW PALTZO • POUGHKEEPSIE SULLIVAN MIDDLETOWN NEWBURGH PUTNAM PORT JERVIS ORANGE WESTCHESTER GENERAL LOCATION MAP

CONTRACT NO. TS-166

PANTHERKILL ROAD BRIDGE REPLACEMENT NY RISING COMMUNITY RECONSTRUCTION PROGRAM NEW YORK STATE GOVERNOR'S OFFICE OF STORM RECOVERY

TOWN OF SHANDAKEN ULSTER COUNTY

NEW YORK

TOWN OFFICIALS

ROBERT A. STANLEY, TOWN SUPERVISOR

TOWN COUNCIL TIMOTHY MALLORY FAYE STORMS PETER DISCIAFANI GAEL ALBA

JOYCE GRANT, TOWN CLERK ERIC HOFMEISTER, HIGHWAY SUPERINTENDENT

JULY 2016

BRINNIER AND LARIOS, P. C. AND LAND PROFESSIONAL ENGINEERS SURVEYORS 67 MAIDEN LANE

Know what's below.

Call before you dig.

KINGSTON, NEW YORK (845) 338-7622

bearing a licensed engineer's seal is a violation of section 7209, subdivision 2, of the



JOHN STINEMIRE, P.E., CONSULTING ENGINEER 15 RAILROAD AVENUE KINGSTON, NEW YORK 12401 845-331-8806

SHEET INDEX SHEET NO. **DESCRIPTION**


> TEMPORARY BYPASS ROAD STREAM PROTECTION AND DEMOLITION PLANS SITE PLAN GRADING PLAN TEMPORARY BYPASS ROAD\STREAM PROTECTION - PHASE 2 RETAINING WALL PLAN STATE LAND RESTORATION WITH TREE PLANTING FOUNDATION PLAN AND STRUCTUAL NOTES


BRIDGE FRAMING PLAN PRECAST DECK PANEL PLAN SECTIONS AND DETAILS


EXISTING CONDITIONS

DETAILS GUIDE RAIL PLAN

GUIDE RAIL DETAILS SECTION AND DETAILS

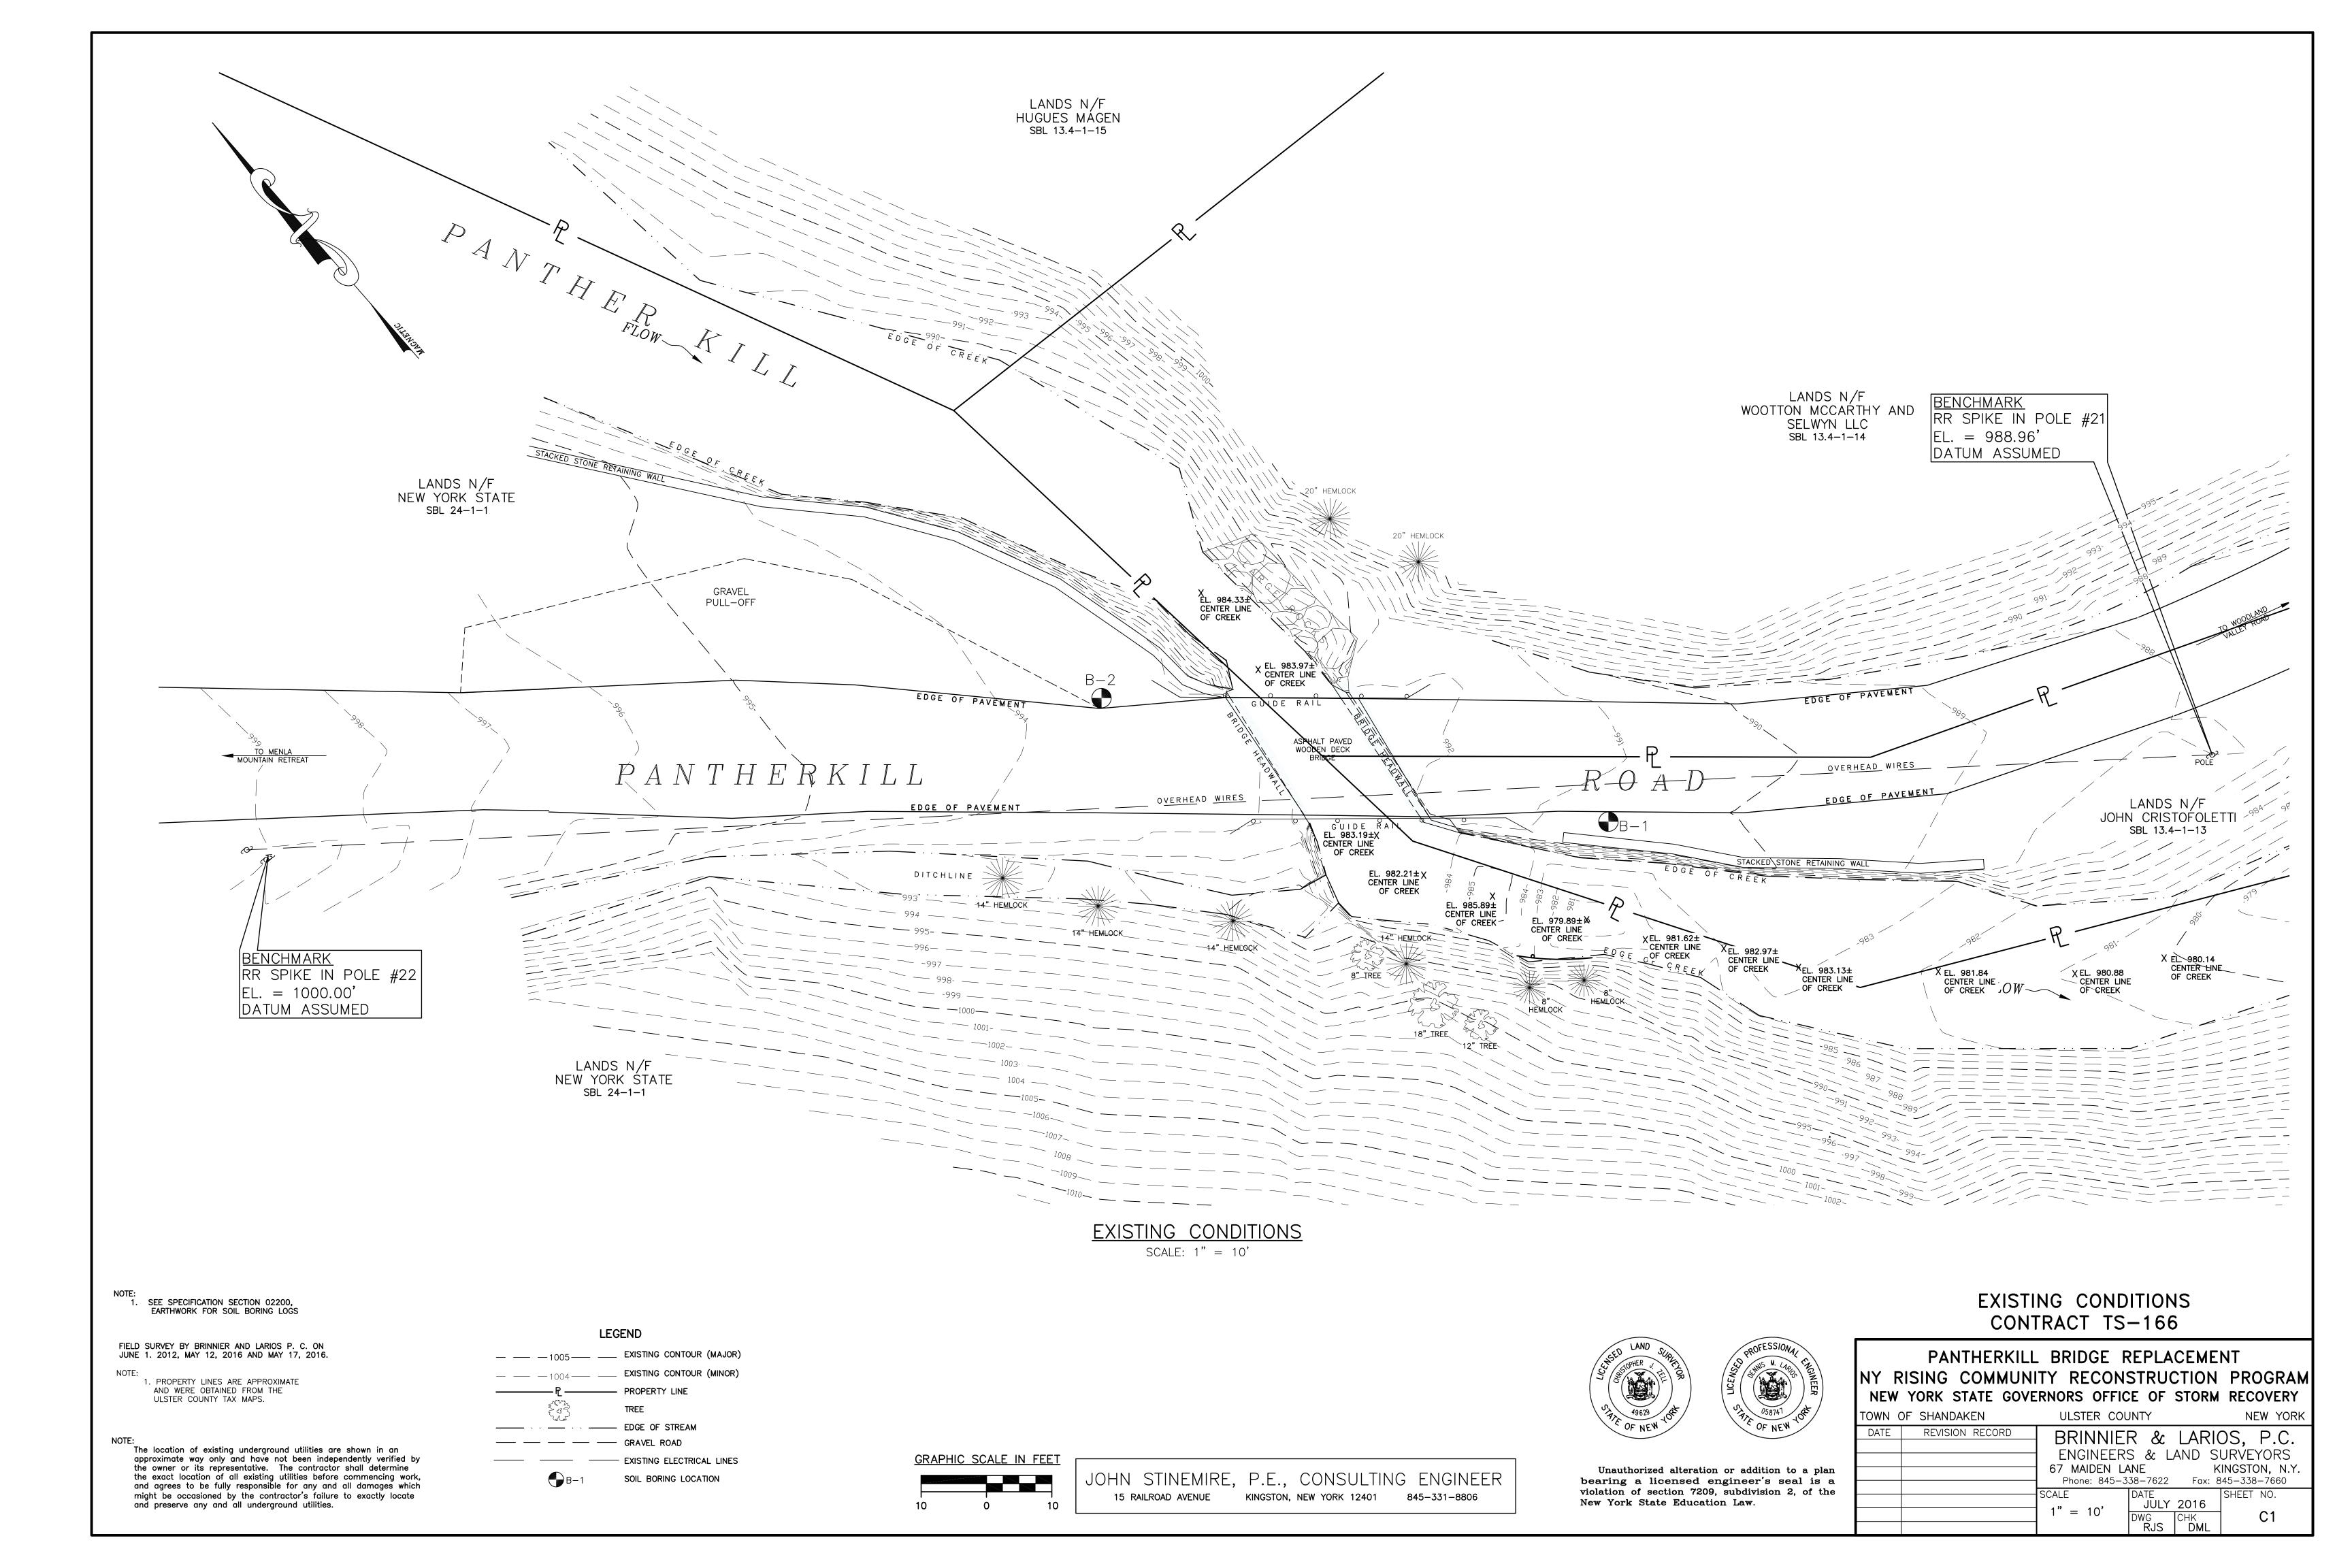

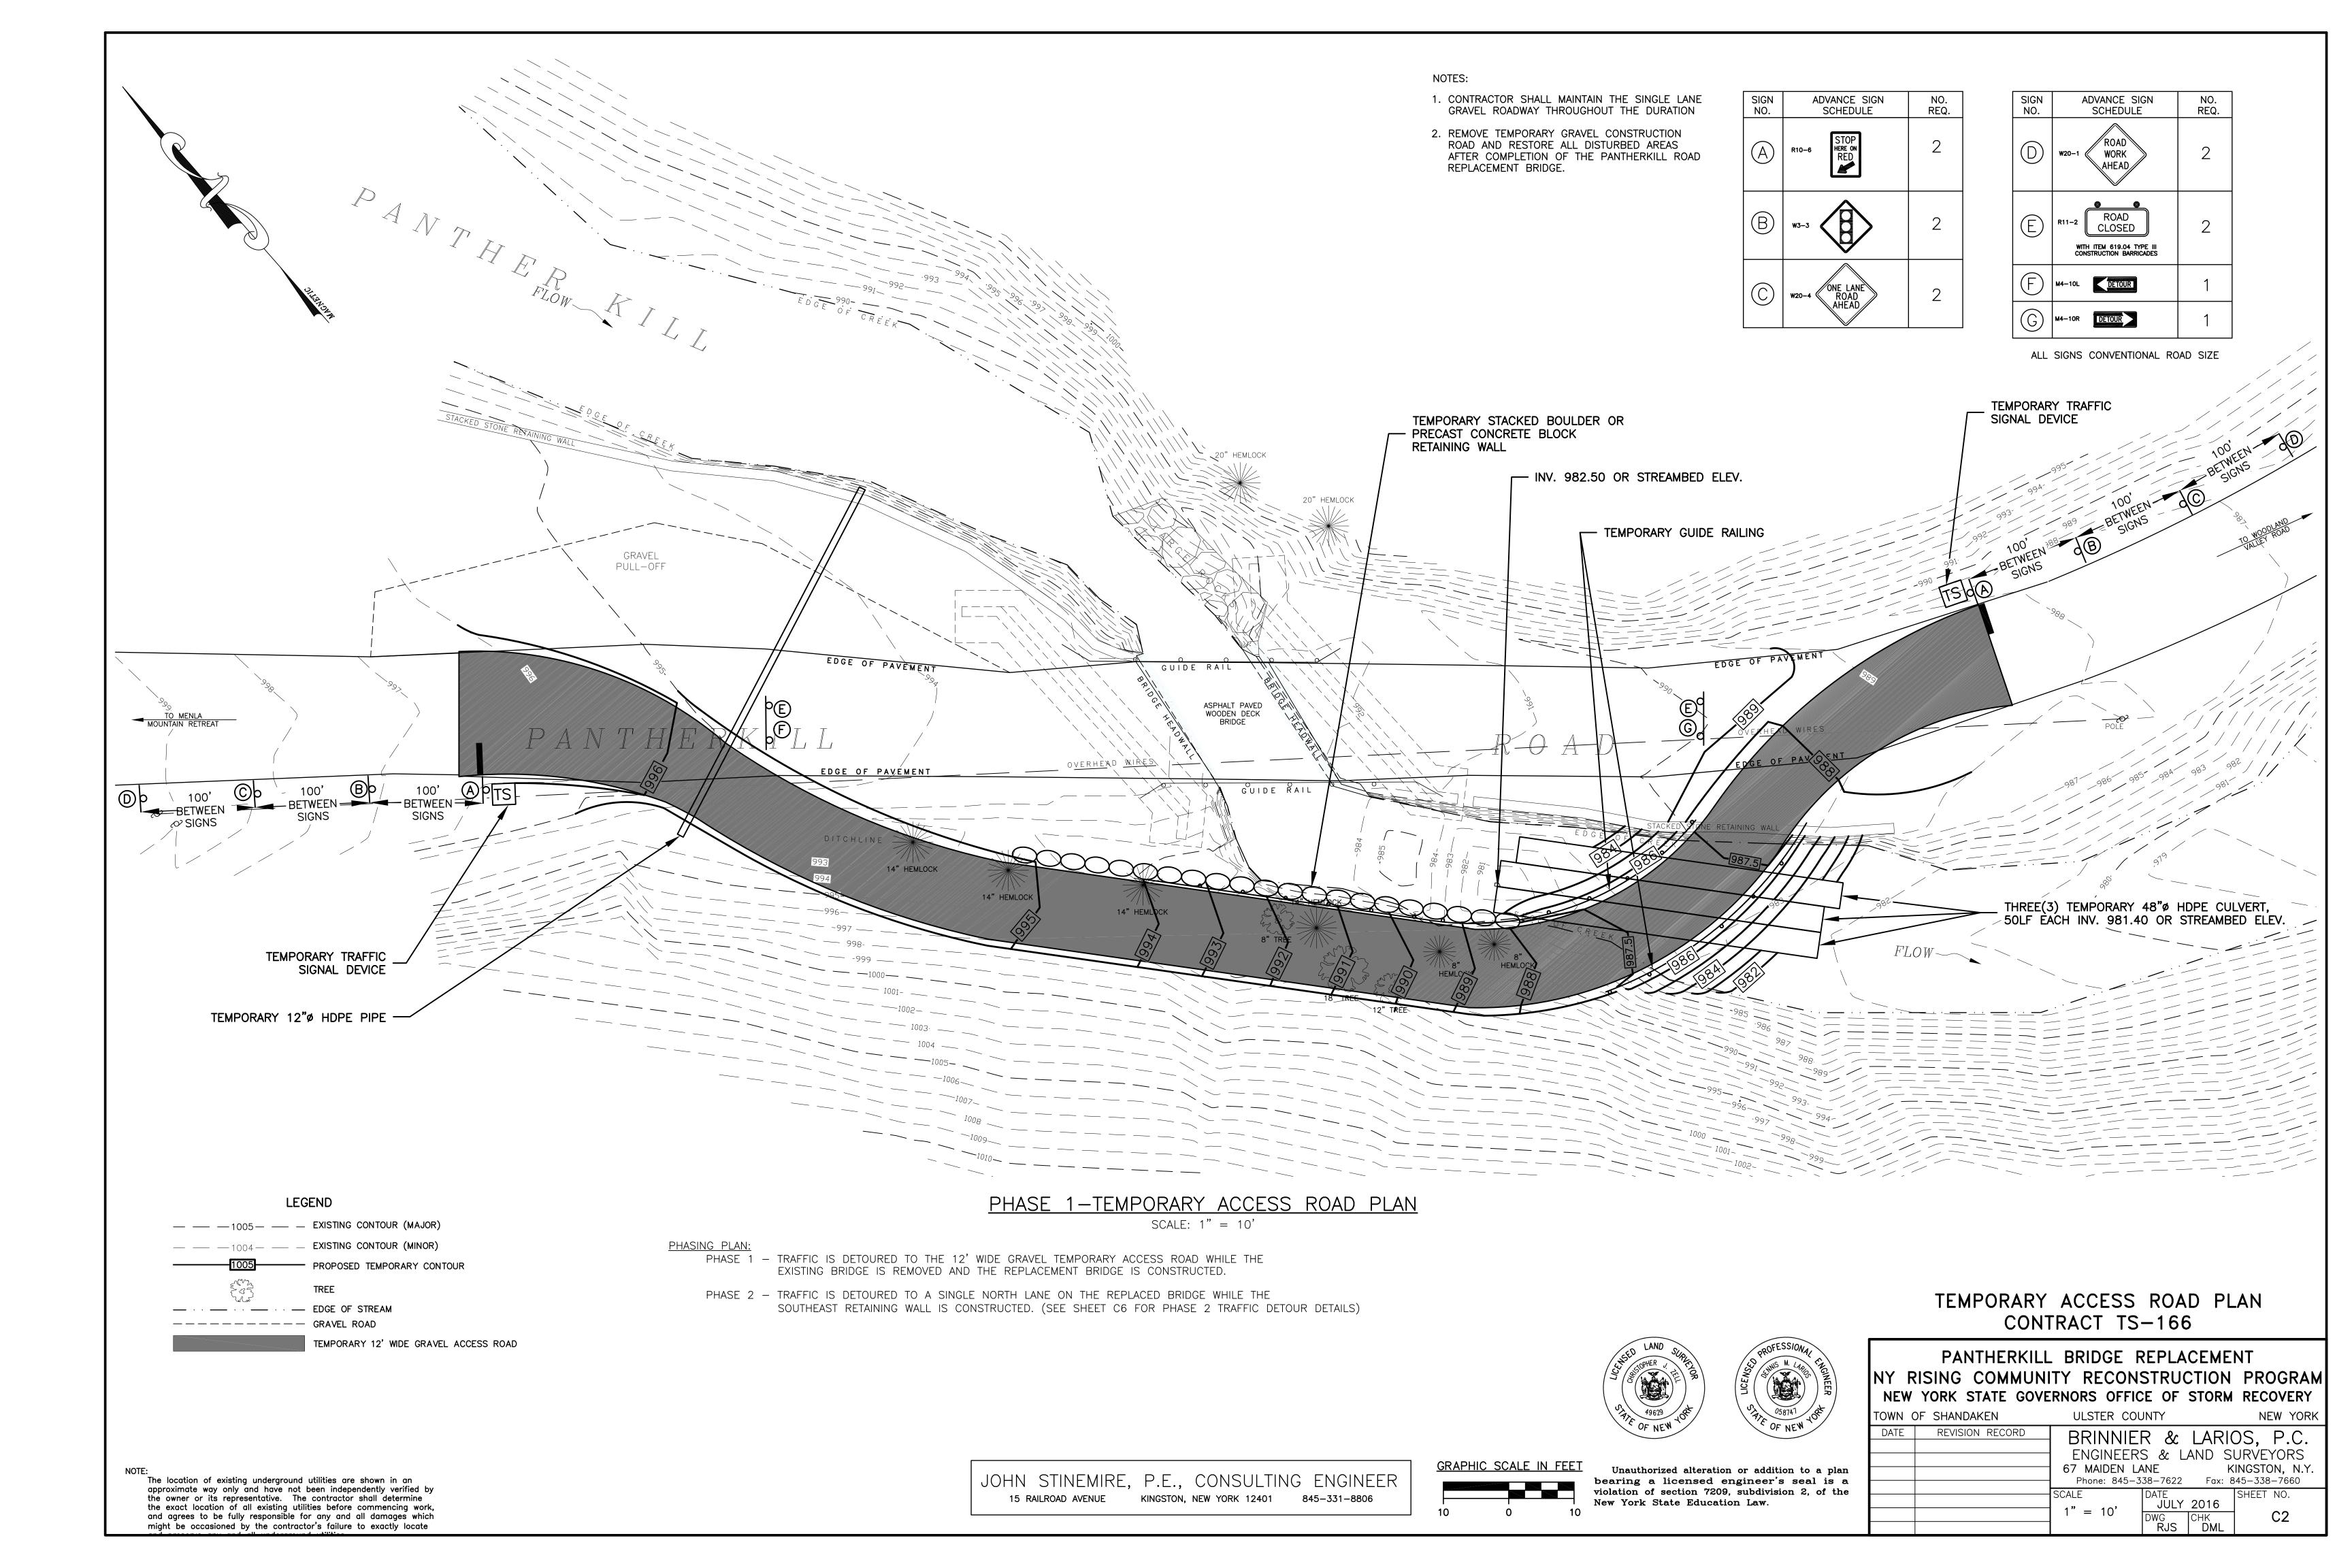

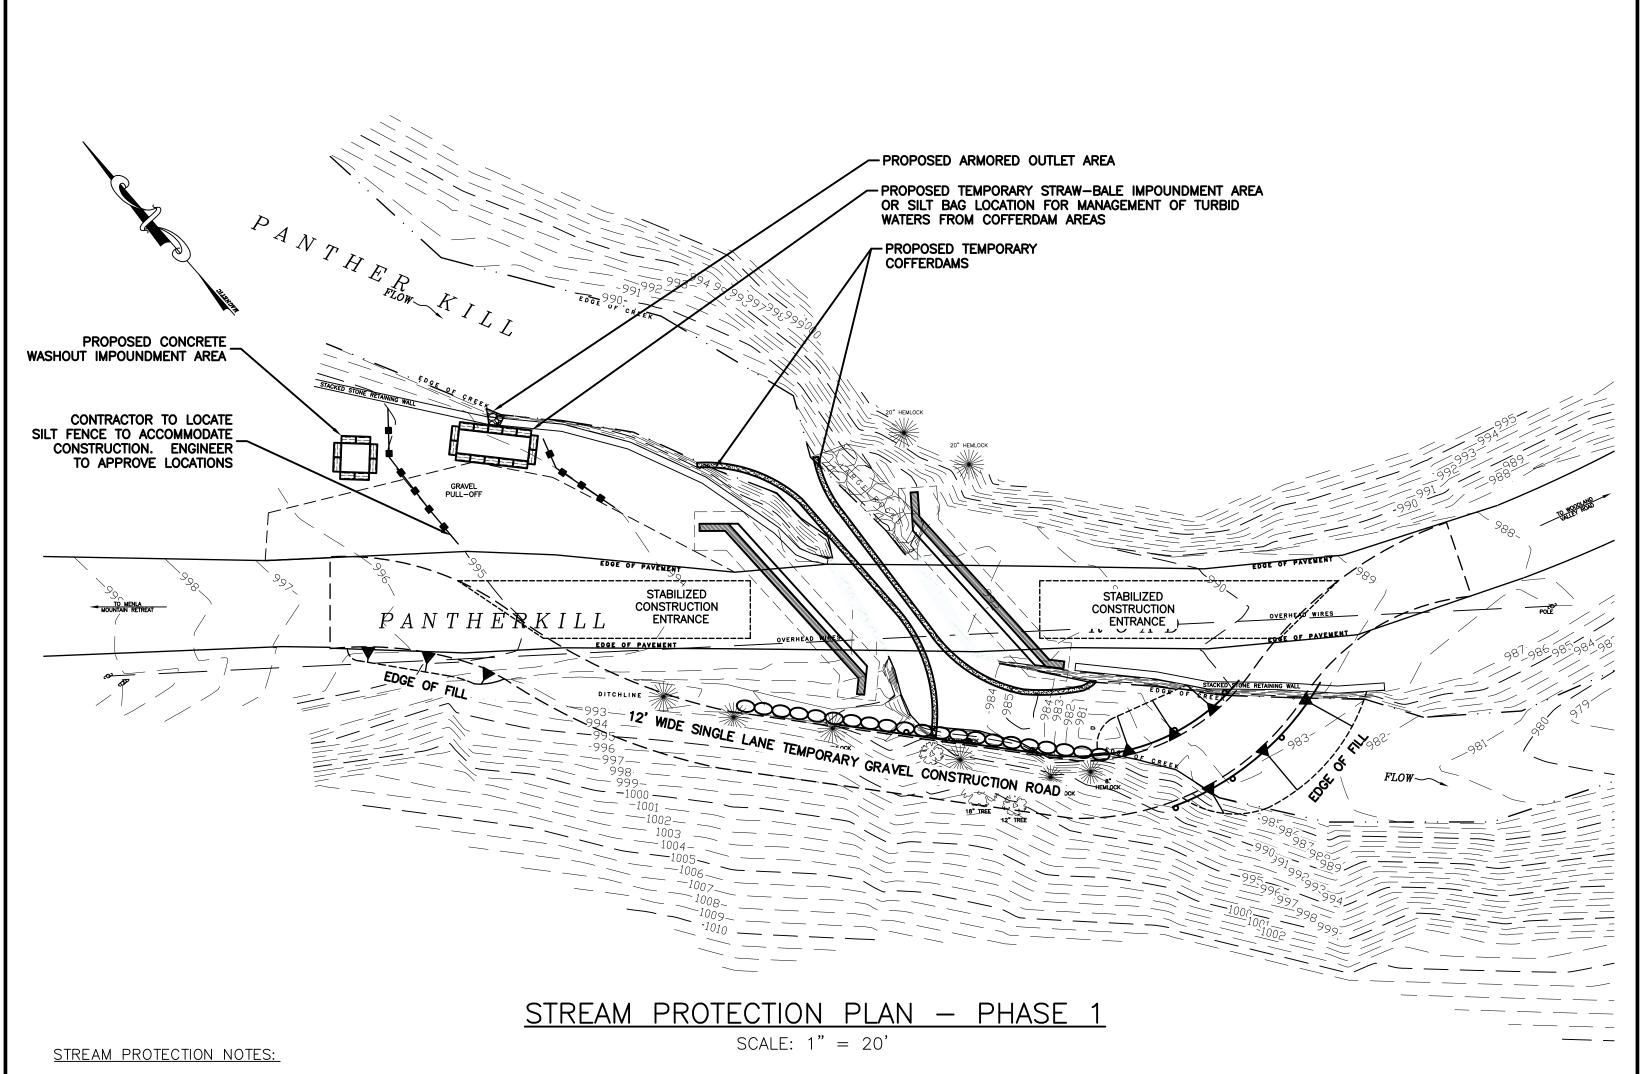

- A. THE STREAM PROTECTION PLAN INVOLVES THE CONSTRUCTION OF TEMPORARY COFFERDAMS TO ISOLATE THE WORK AREA. THE PURPOSE OF THE TEMPORARY COFFERDAMS IS TO ALLOW THE STREAM TO FLOW PAST THE WORK AREA AND TO CONTAIN THE SEDIMENT AND SOIL FROM THE CONSTRUCTION ACTIVITIES WITH LITTLE OR NO IMPACT TO THE STREAM. THE GENERAL SEQUENCE OF THE OPERATION WILL BE AS FOLLOWS:
- 1. INSTALL SILT FENCE ALONG THE PERIMETER OF THE AREA TO BE DISTURBED.

BE HALTED IN EXTREME WET WEATHER CONDITIONS

NOT PLACED IN THE WATERWAY OR FLOODPLAIN.

- 2. INSTALL THE TEMPORARY COFFERDAM ON ONE SIDE OF THE STREAM PRIOR TO COMMENCING THE ABUTMENT DEMOLITION AND CONSTRUCTION WORK. AFTER WORK ON ONE ABUTMENT IS COMPLETED, REMOVE AND REPOSITION THE TEMPORARY COFFERDAM TO THE OTHER SIDE OF COFFERDAM SHOULD BE SAND BAGS, PRECAST CONCRETE JERSEY BARRIERS OR IMPERVIOUS GEOSYNTHETIC LINER MATERIAL(S) KEYED INTO STREAMBED.
- 3. IN STREAM EXCAVATION. IN-STREAM EXCAVATION SHALL BE LIMITED TO ONLY THAT NECESSARY TO ALLOW INSTALLATION AND MAINTENANCE OF THE TEMPORARY COFFERDAM.
- 4. BRIDGE REPAIR WORK SHOULD BE CONDUCTED DURING LOW-FLOW SEASON AND SHOULD
- 5. <u>INSPECTION AND MAINTENANCE</u>. PERIODICALLY INSPECT THE TEMPORARY COFFERDAM TO INSURE ITS INTEGRITY AND FUNCTIONALITY. REPAIR AS NECESSARY.
- 6. REMOVAL. WHEN THE CONSTRUCTION WORK IS COMPLETED, THE TEMPORARY COFFERDAM MATERIALS SHALL BE REMOVED. ALL REMOVED MATERIALS SHALL BE TAKEN OFF-SITE AND
- 7. <u>DEWATERING</u>. REMOVAL OF WATER FROM WITHIN THE COFFERDAM AREA SHALL BE ACCOMPLISHED USING A PUMP(S). THE PUMP(S) SHALL BE DISCHARGED IN A CONTROLLED MANNER TO A IMPOUNDMENT AREA, DEPRESSION OR SEDIMENT BAG LOCATED ADJACENT TO THE WORK AREA TO ALLOW REMOVAL OF SEDIMENT AND SUSPENDED SOLIDS BEFORE THE WATER RE-ENTERS THE STREAM. DISCHARGING THE PUMP DIRECTLY TO THE STREAM IS
- 8. PLACEMENT OF CONCRETE MATERIALS OR DISCHARGE OF CONCRETE WASH WATERS DIRECTLY INTO THE STREAM IS PROHIBITED.
- 9. DISTURBED AREAS SHALL BE STABILIZED IMMEDIATELY AFTER CONSTRUCTION ACTIVITY CEASES. IF A WORK AREA IS TO REMAIN IDLE FOR MORE THAN TWO WEEKS, APPLY TEMPORARY SEED AND MULCH TO PROTECT THE AREA.
- B. CONTRACTOR SHALL SUBMIT DETAILS OF THEIR STREAM PROTECTION PLAN FOR APPROVAL.
- C. ALL WORK TO BE DONE IN ACCORDANCE WITH THE TERMS AND CONDITIONS OF NYSDEC AND USACE ENVIROMENTAL PERMITS.


LEGEND - - 1005 - - EXISTING CONTOUR (MAJOR) -- -1004-- - EXISTING CONTOUR (MINOR) ___ · · __ · · __ EDGE OF STREAM — — — — GRAVEL ROAD

PROPOSED SILT FENCE


and agrees to be fully responsible for any and all damages which might be occasioned by the contractor's failure to exactly locate

The location of existing underground utilities are shown in an approximate way only and have not been independently verified by the owner or its representative. The contractor shall determine the exact location of all existing utilities before commencing work,

and preserve any and all underground utilities.

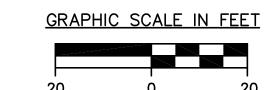

WOVEN WIRE FENCE

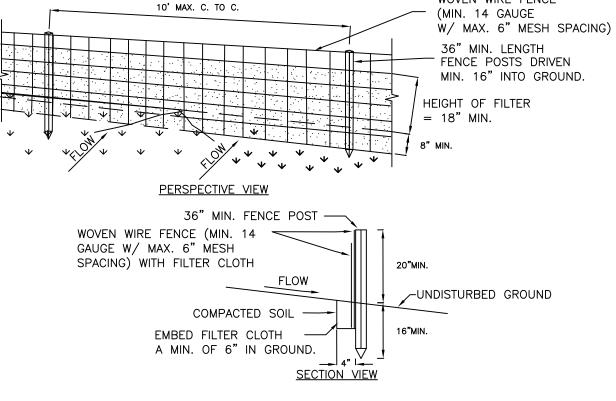


CONSTRUCTION SPECIFICATIONS


- 1. WOVEN WIRE FENCE TO BE FASTENED SECURELY TO FENCE POSTS WITH WIRE TIES OR STAPLES. POSTS SHALL BE STEEL EITHER "T" OR "U" TYPE OR
- 2. FILTER CLOTH TO BE TO BE FASTENED SECURELY TO WOVEN WIRE FENCE WITH TIES SPACED EVERY 24" AT TOP AND MID SECTION. FENCE SHALL BE
- WOVEN WIRE, 12 1/2 GAUGE, 6" MAXIMUM MESH OPENING.

 3. WHEN TWO SECTIONS OF FILTER CLOTH ADJOIN EACH OTHER THEY SHALL BE OVER—LAPPED BY SIX INCHES AND FOLDED. FILTER CLOTH SHALL BE EITHER
- FILTER X, MIRAFI 100X, STABILINKA T140N, OR APPROVED EQUIVALENT.
- 4. PREFABRICATED UNITS SHALL BE GEOFAB, ENVIROFENCE, OR APPROVED EQUIVALENT. 5. MAINTENANCE SHALL BE PERFORMED AS NEEDED AND MATERIAL REMOVED WHEN
- "BULGES" DEVELOP IN THE SILT FENCE. 6. SILT FENCE LOCATIONS AS DEPICTED ON PLANS ARE ILLUSTRATIVE. CONTRACTOR SHALL EXERCISE DILIGENCE WHEN INSTALLING SILT FENCE TO CAPTURE ALL

SILT FENCE DETAIL NOT TO SCALE

JOHN STINEMIRE, P.E., CONSULTING ENGINEER 15 RAILROAD AVENUE KINGSTON, NEW YORK 12401 845-331-8806

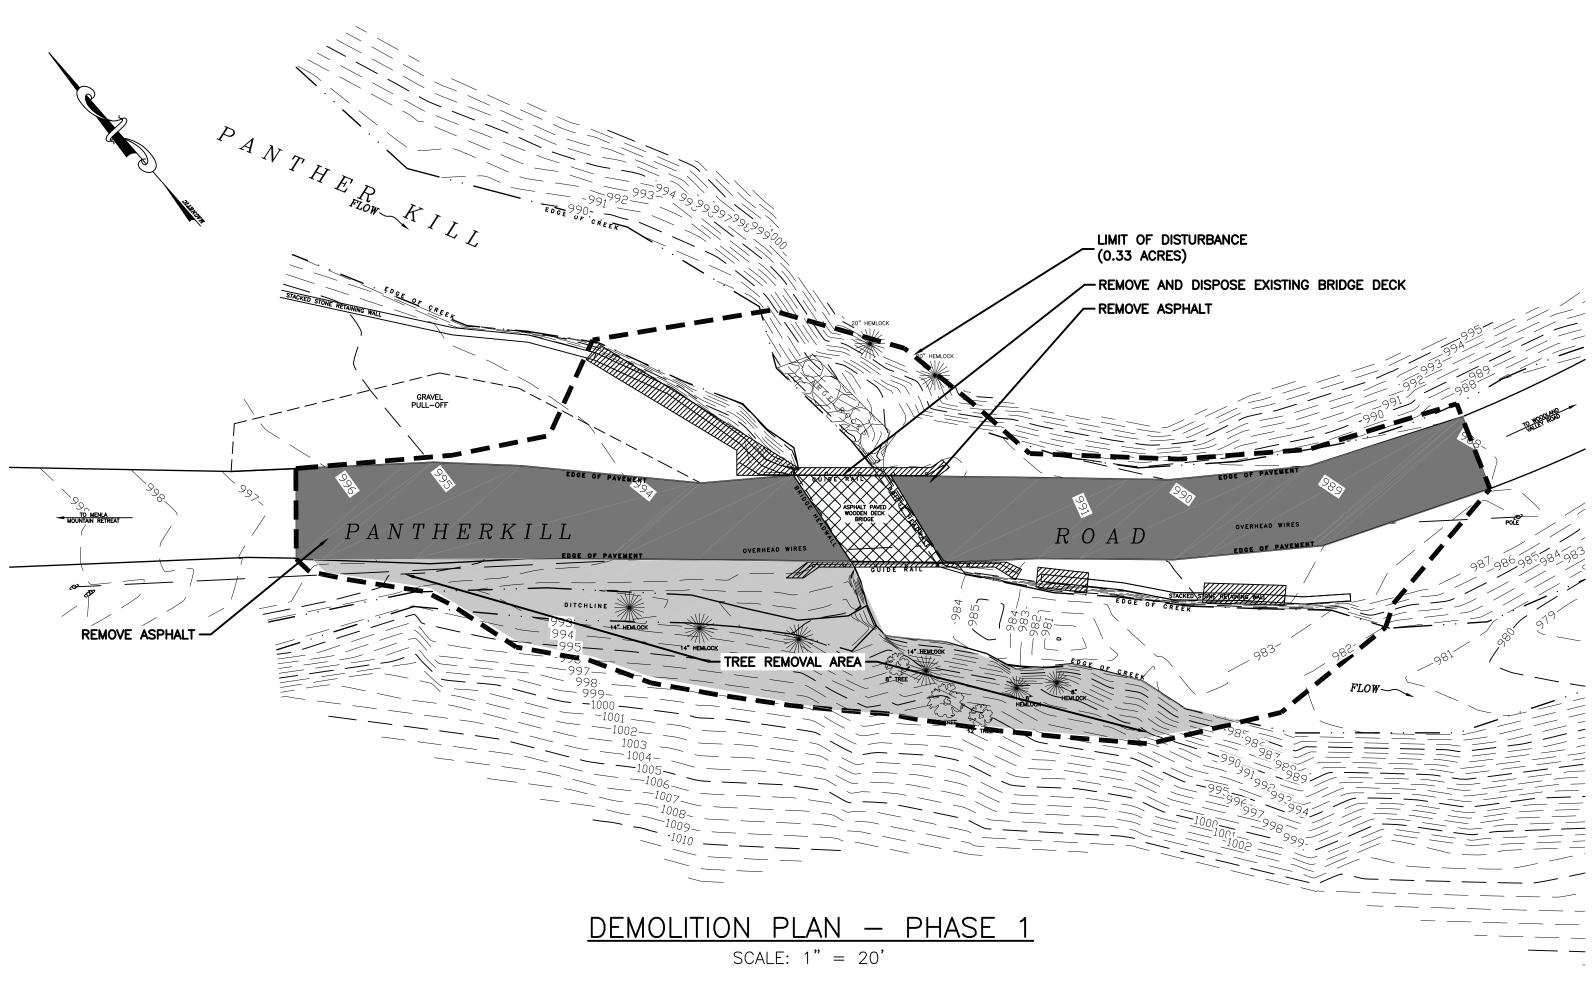

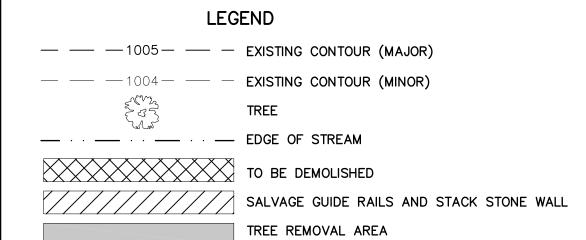








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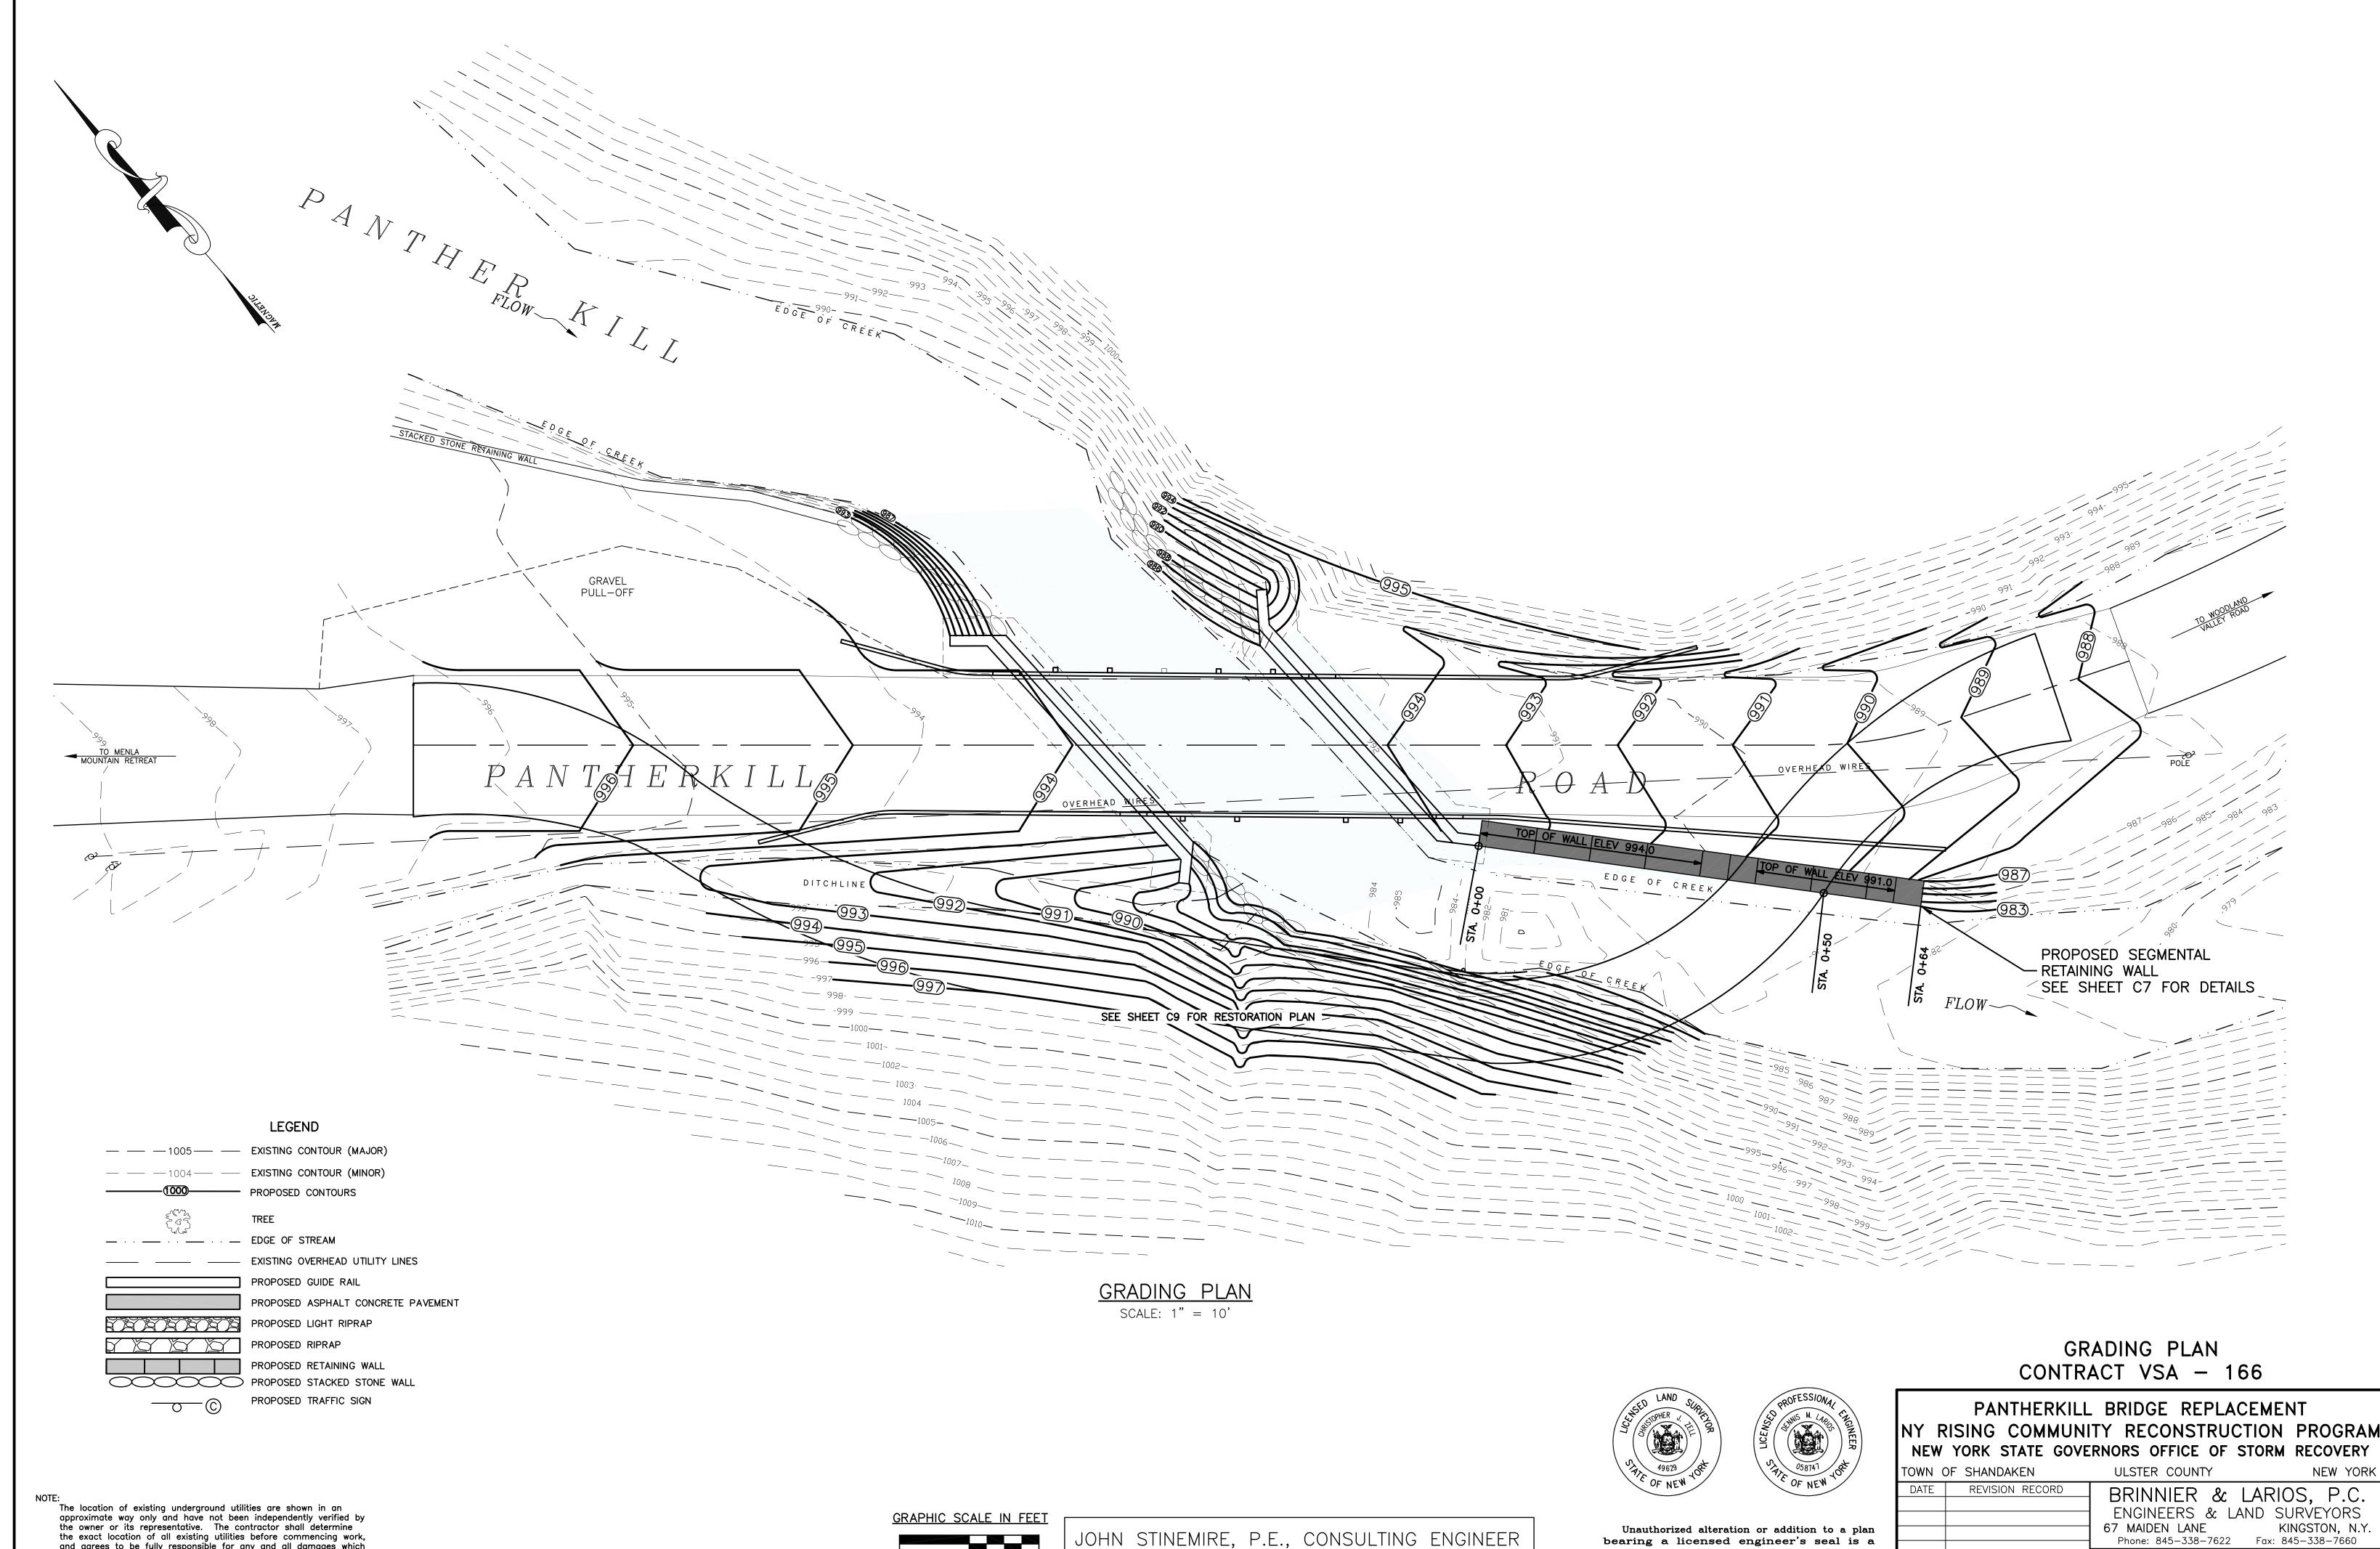
STREAM PROTECTION AND DEMOLITION CONTRACT TS-166

GRAPHIC SCALE IN FEET



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SURVEYORS
DONVETONS
KINGSTON, N.Y.
845-338-7660
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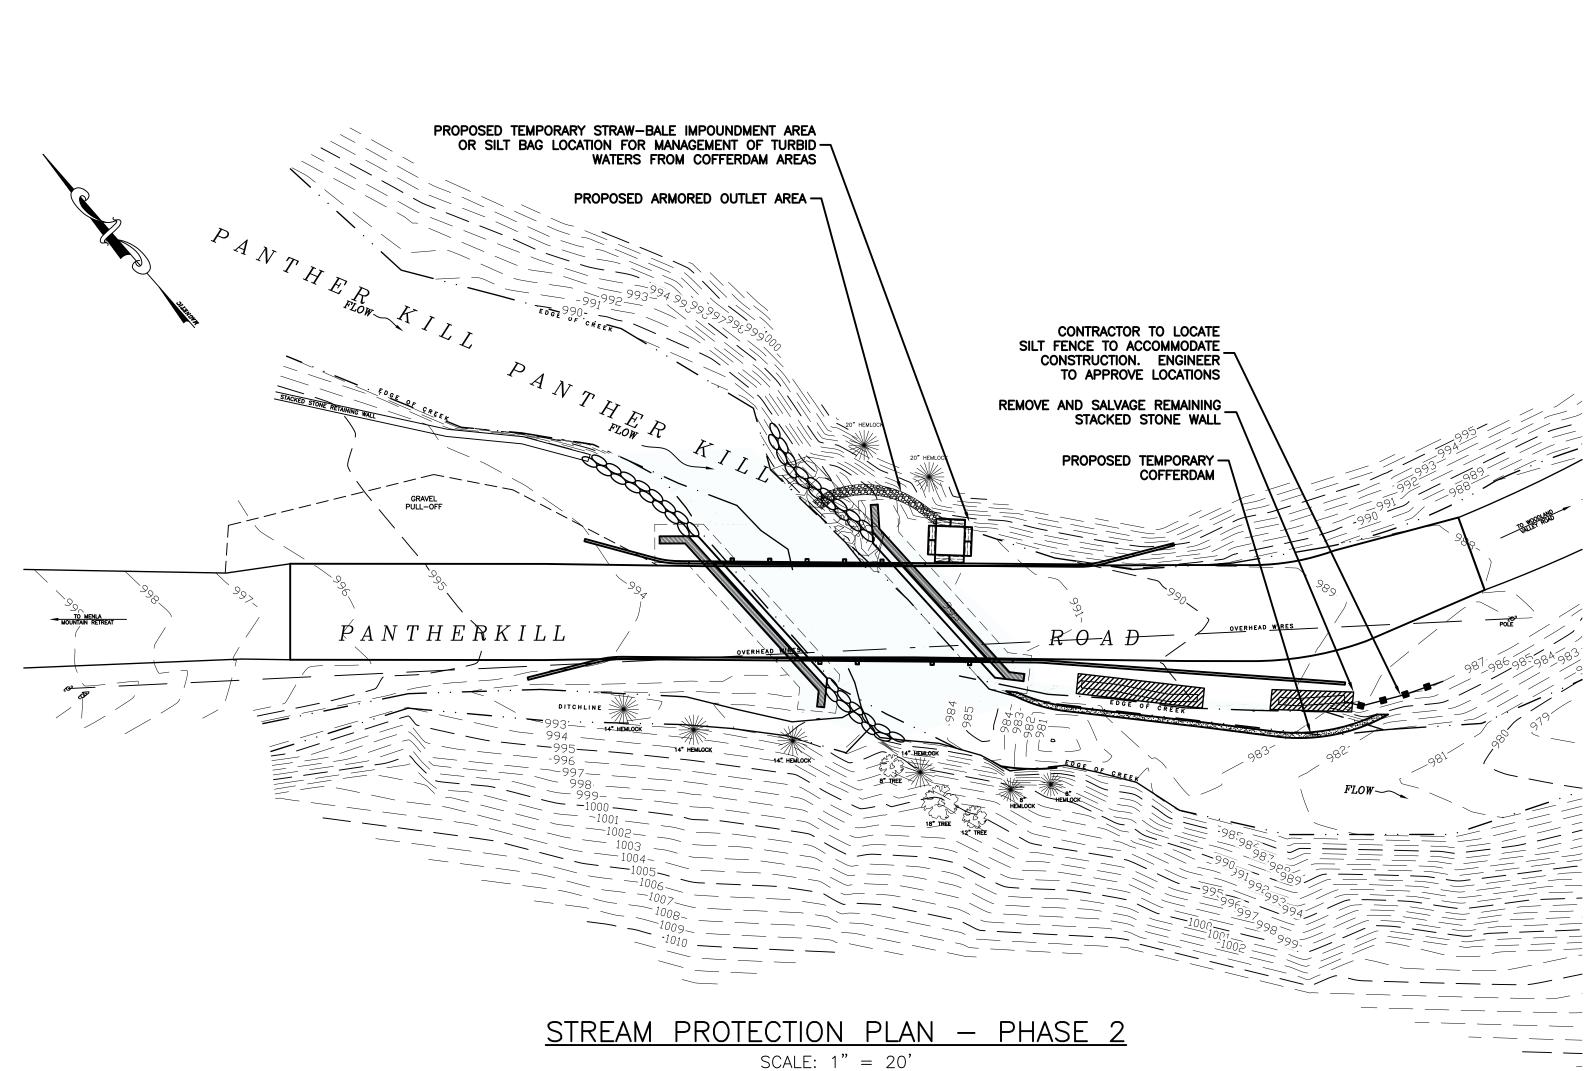


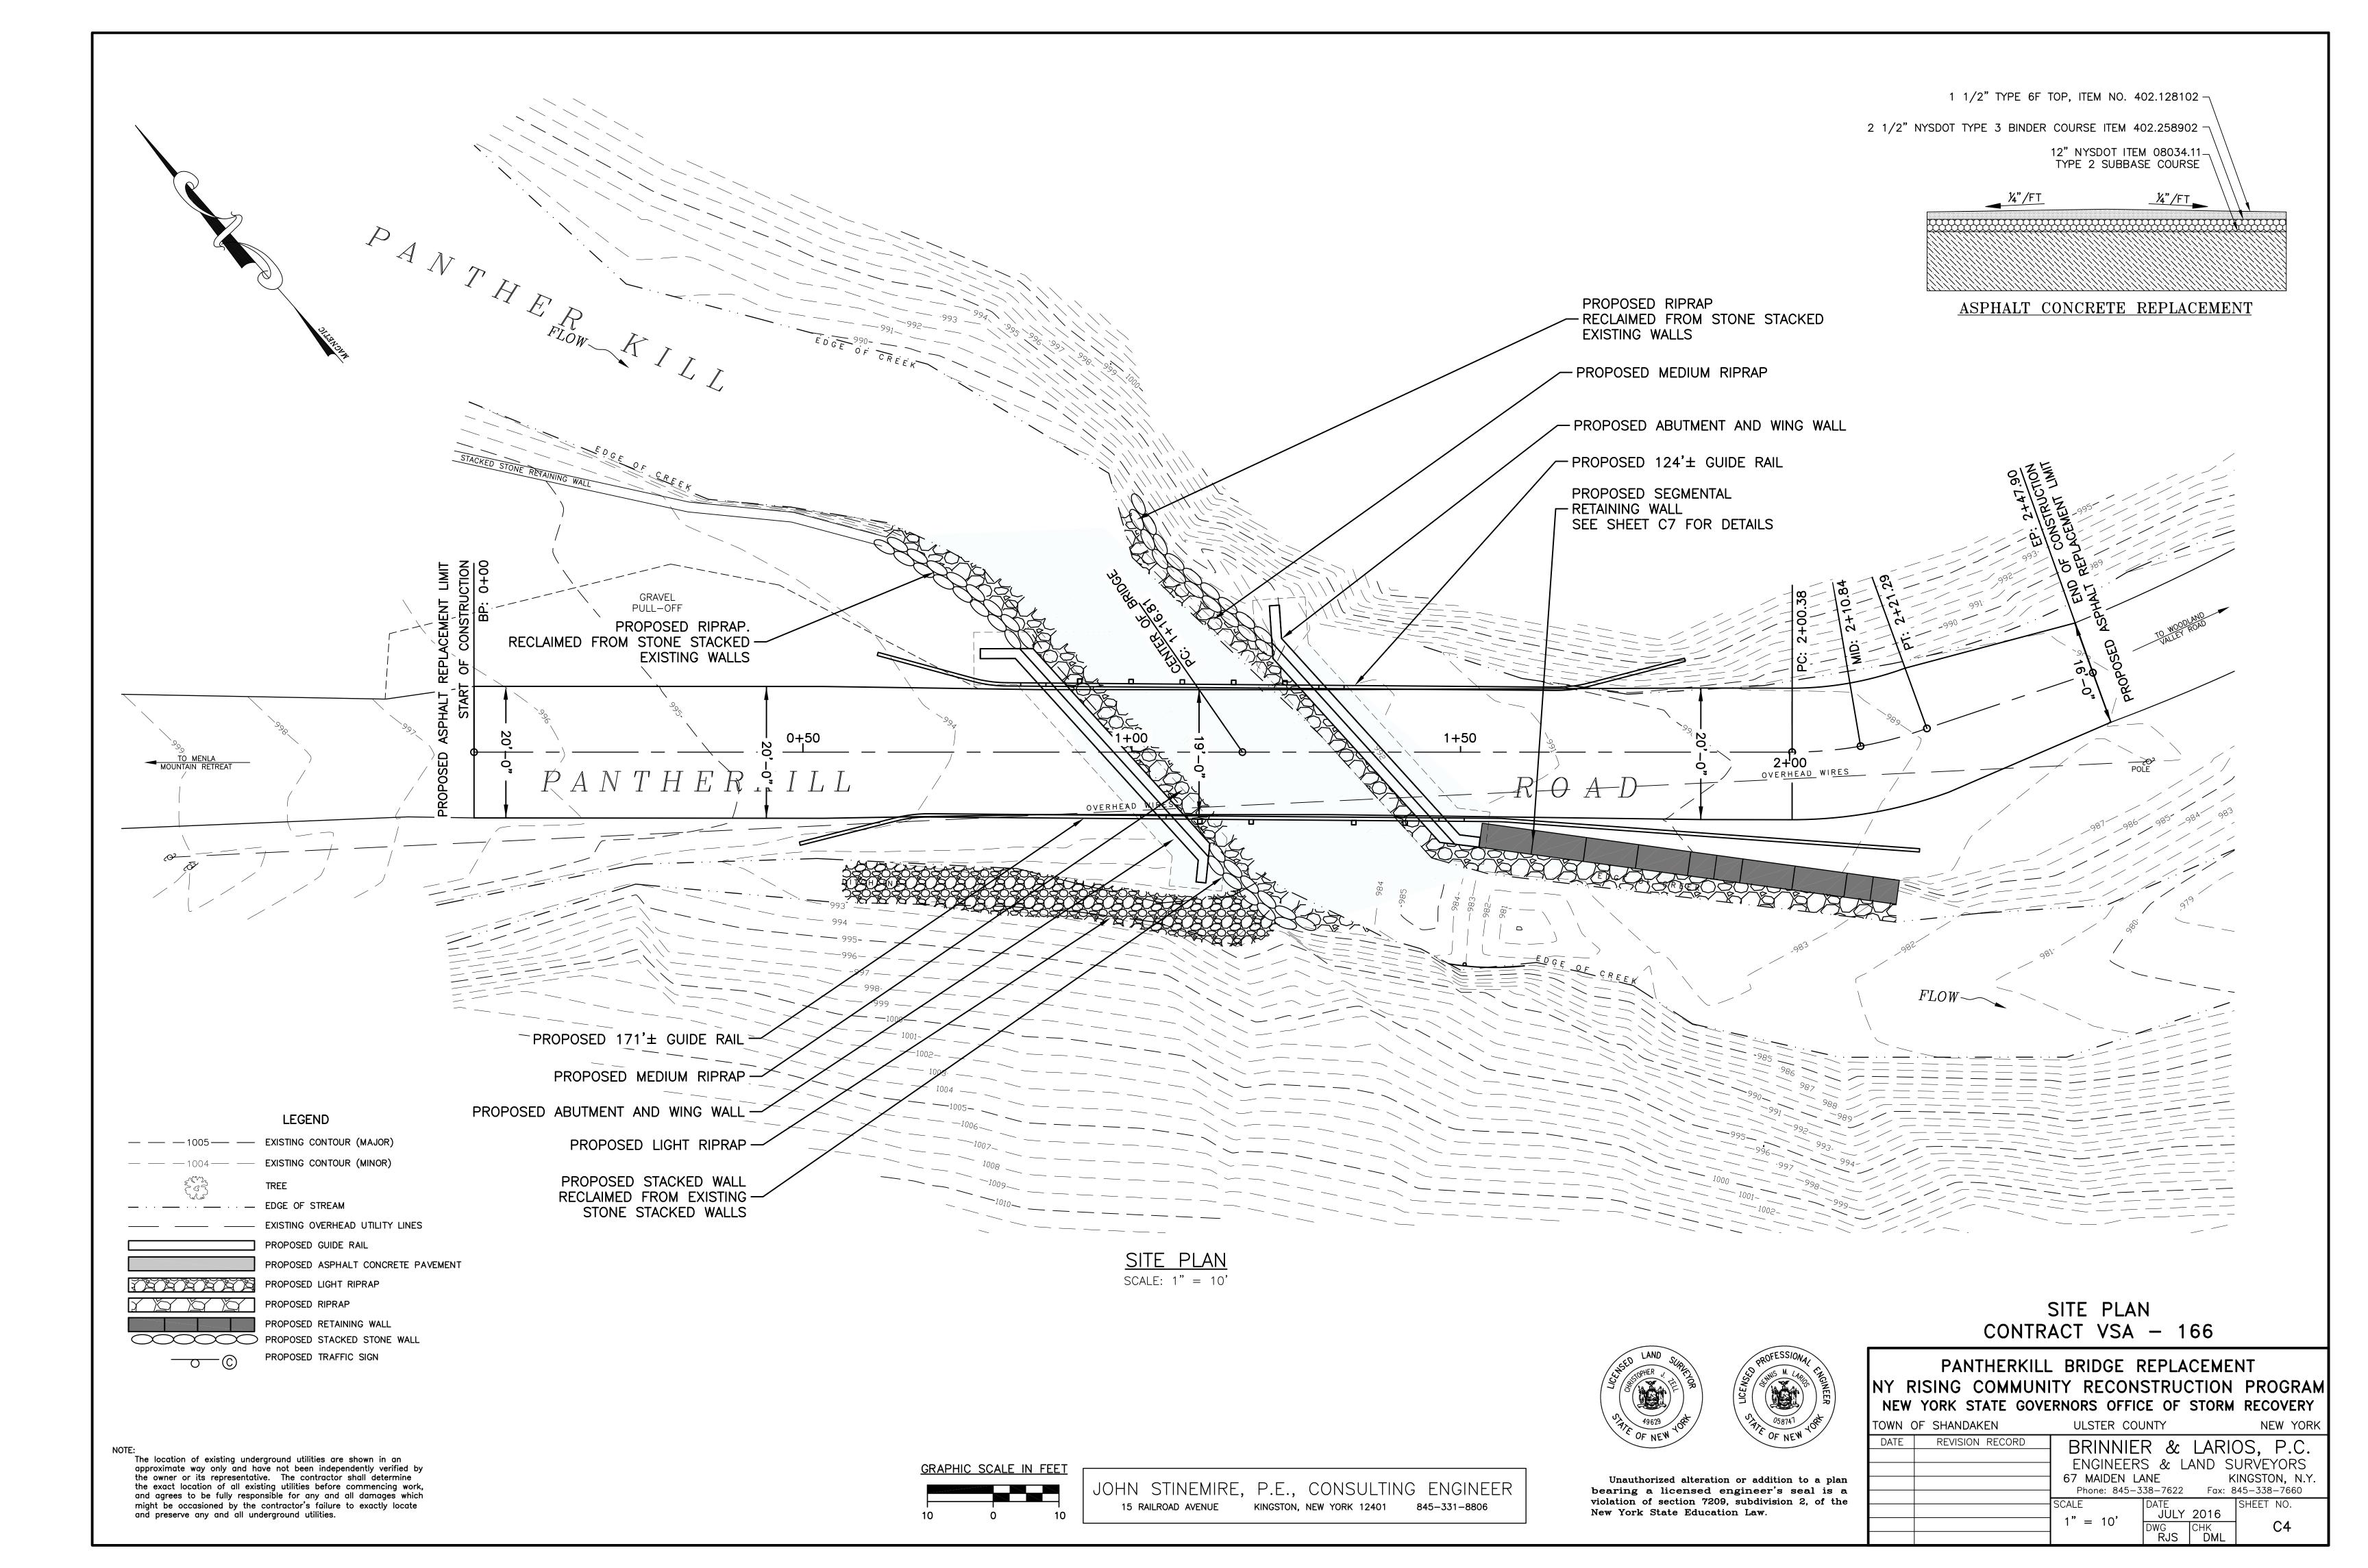


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15 RAILROAD AVENUE KINGSTON, NEW YORK 12401 845-331-8806

TOWN	OF SHANDAKEN	ULSTER COL	JNTY	NEW YORK
DATE	REVISION RECORD	BRINNIFI	? &: 1	ARIOS, P.C.
				ID SURVEYORS
		67 MAIDEN LA		KINGSTON, N.Y.
		Phone: 845-338-7622 Fax: 845-338-7660		
		SCALE	DATE	SHEET NO.
		l .,,	JULY 20)16



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- 1. INSTALL SILT FENCE ALONG THE PERIMETER OF THE AREA TO BE DISTURBED.
- 2. INSTALL THE TEMPORARY COFFERDAM AROUND THE RETAINING WALL WORK AREA. COFFERDAM SHOULD BE SAND BAGS, PRECAST CONCRETE JERSEY BARRIERS OR IMPERVIOUS GEOSYNTHETIC LINER MATERIAL(S) KEYED INTO STREAMBED.
- 3. IN STREAM EXCAVATION. IN-STREAM EXCAVATION SHALL BE LIMITED TO ONLY THAT NECESSARY TO ALLOW INSTALLATION AND MAINTENANCE OF THE TEMPORARY COFFERDAM.
- 4. <u>RETAINING WALL CONSTRUCTION</u> SHOULD BE CONDUCTED DURING LOW-FLOW SEASON AND SHOULD BE HALTED IN EXTREME WET WEATHER CONDITIONS
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TO BE DEMOLISHED

JOHN STINEMIRE, P.E., CONSULTING ENGINEER

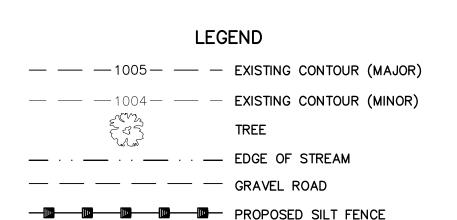WOVEN WIRE FENCE (MIN. 14 GAUGE W/ MAX. 6" MESH SPACING 36" MIN. LENGTH FENCE POSTS DRIVEN MIN. 16" INTO GROUND. HEIGHT OF FILTER = 18" MIN. 36" MIN. FENCE POST — WOVEN WIRE FENCE (MIN. 14 GAUGE W/ MAX. 6" MESH SPACING) WITH FILTER CLOTH _UNDISTURBED GROUND COMPACTED SOIL --EMBED FILTER CLOTH -A MIN. OF 6" IN GROUND. SECTION VIEW


CONSTRUCTION SPECIFICATIONS

- 1. WOVEN WIRE FENCE TO BE FASTENED SECURELY TO FENCE POSTS WITH WIRE TIES OR STAPLES. POSTS SHALL BE STEEL EITHER "T" OR "U" TYPE OR HARDWOOD.
- 2. FILTER CLOTH TO BE TO BE FASTENED SECURELY TO WOVEN WIRE FENCE WITH TIES SPACED EVERY 24" AT TOP AND MID SECTION. FENCE SHALL BE WOVEN WIRE, 12 1/2 GAUGE, 6" MAXIMUM MESH OPENING. 3. WHEN TWO SECTIONS OF FILTER CLOTH ADJOIN EACH OTHER THEY SHALL BE OVER-LAPPED BY SIX INCHES AND FOLDED. FILTER CLOTH SHALL BE EITHER FILTER X, MIRAFI 100X, STABILINKA T140N, OR APPROVED EQUIVALENT. 4. PREFABRICATED UNITS SHALL BE GEOFAB, ENVIROFENCE, OR APPROVED
- EQUIVALENT. 5. MAINTENANCE SHALL BE PERFORMED AS NEEDED AND MATERIAL REMOVED WHEN "BULGES" DEVELOP IN THE SILT FENCE.
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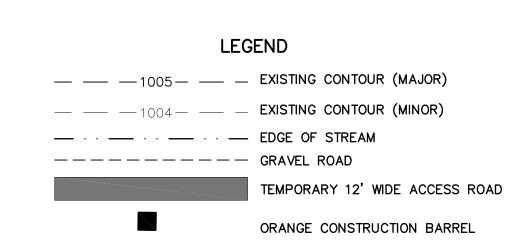
SEDIMENT LADEN RUNOFF.

15 RAILROAD AVENUE KINGSTON, NEW YORK 12401 845-331-8806

SILT FENCE DETAIL NOT TO SCALE

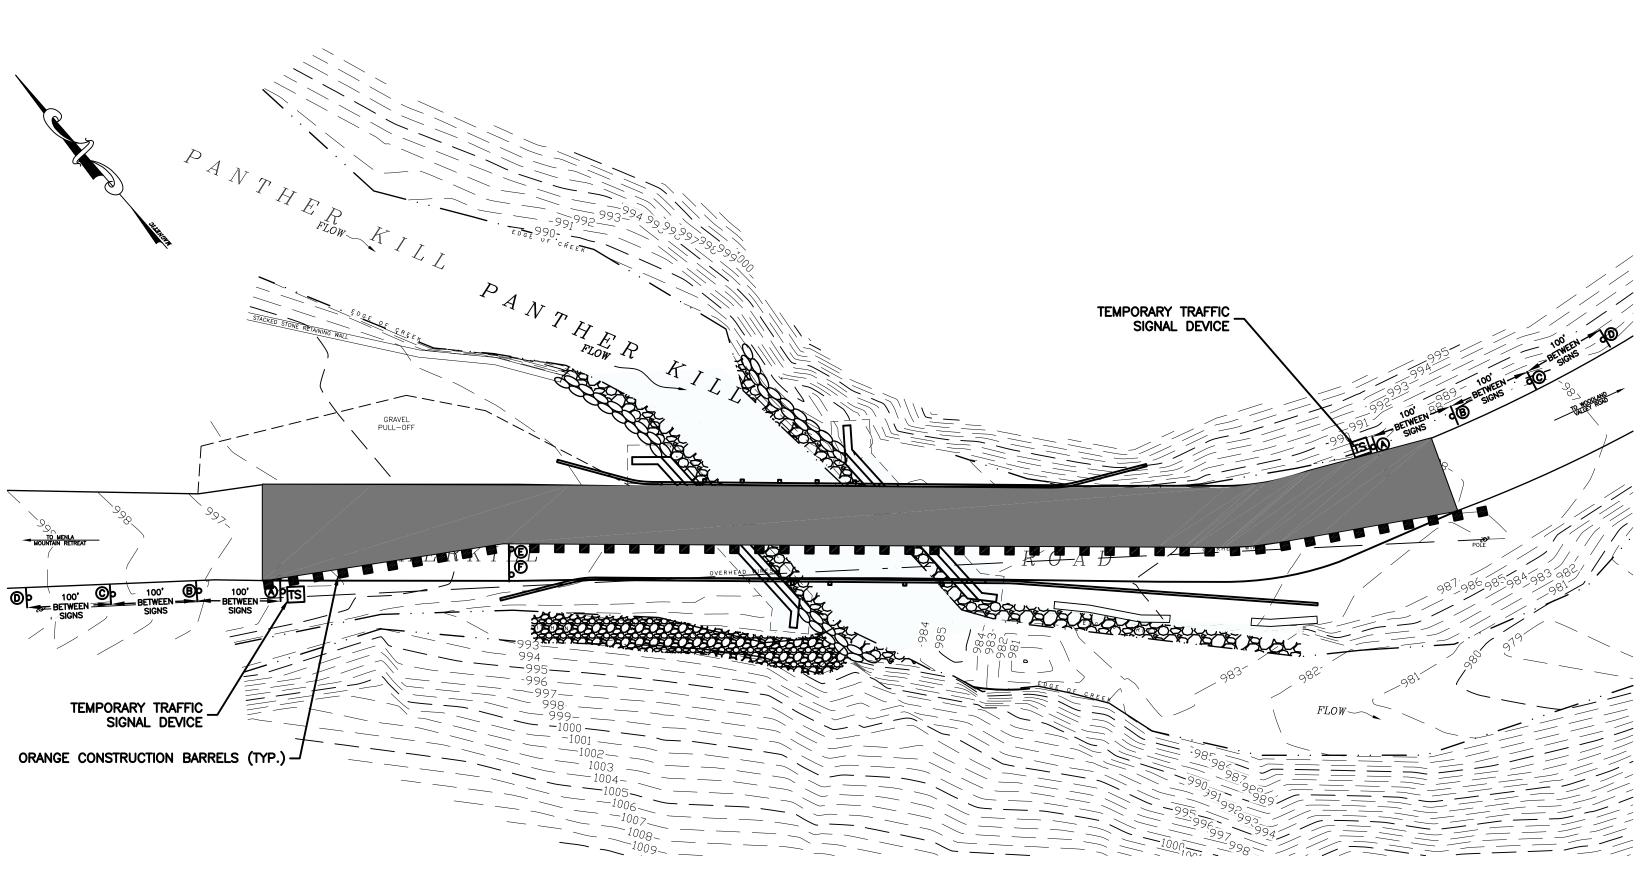

TEMPORARY ACCESS ROAD PLAN - PHASE 2 SCALE: 1" = 20'



SIGN NO.	ADVANCE SIGN SCHEDULE	NO. REQ.
A	STOP HERE ON RED	2
B	w3-3	2
\bigcirc	w20-4 ONE LANE ROAD AHEAD	2

SIGN NO.	ADVANCE SIGN SCHEDULE	NO. REQ.
(D)	W20-1 ROAD WORK AHEAD	2
E	R11-2 ROAD CLOSED WITH ITEM 619.04 TYPE III CONSTRUCTION BARRICADES	2
F	M4-10L DETOUR	1
G	M4-10R DETOUR	1

ALL SIGNS CONVENTIONAL ROAD SIZE

TEMPORARY ACCESS ROAD PLAN AND STREAM PROTECTION - PHASE 2 CONTRACT TS-166






PANTHERKILL BRIDGE REPLACEMENT NY RISING COMMUNITY RECONSTRUCTION PROGRAM NEW YORK STATE GOVERNORS OFFICE OF STORM RECOVERY

OWN	OF SHANDAKEN	ULSTER COL	INTY	NEW YORK
DATE	REVISION RECORD	BRINNIER & LARIOS, P.C. ENGINEERS & LAND SURVEYORS 67 MAIDEN LANE Phone: 845-338-7622 KINGSTON, N.Y Phone: 845-338-7660		
		SCALE 1"=20'	DATE JULY 2016 DWG CHK RJS DMI	SHEET NO.

GRAPHIC SCALE IN FEET

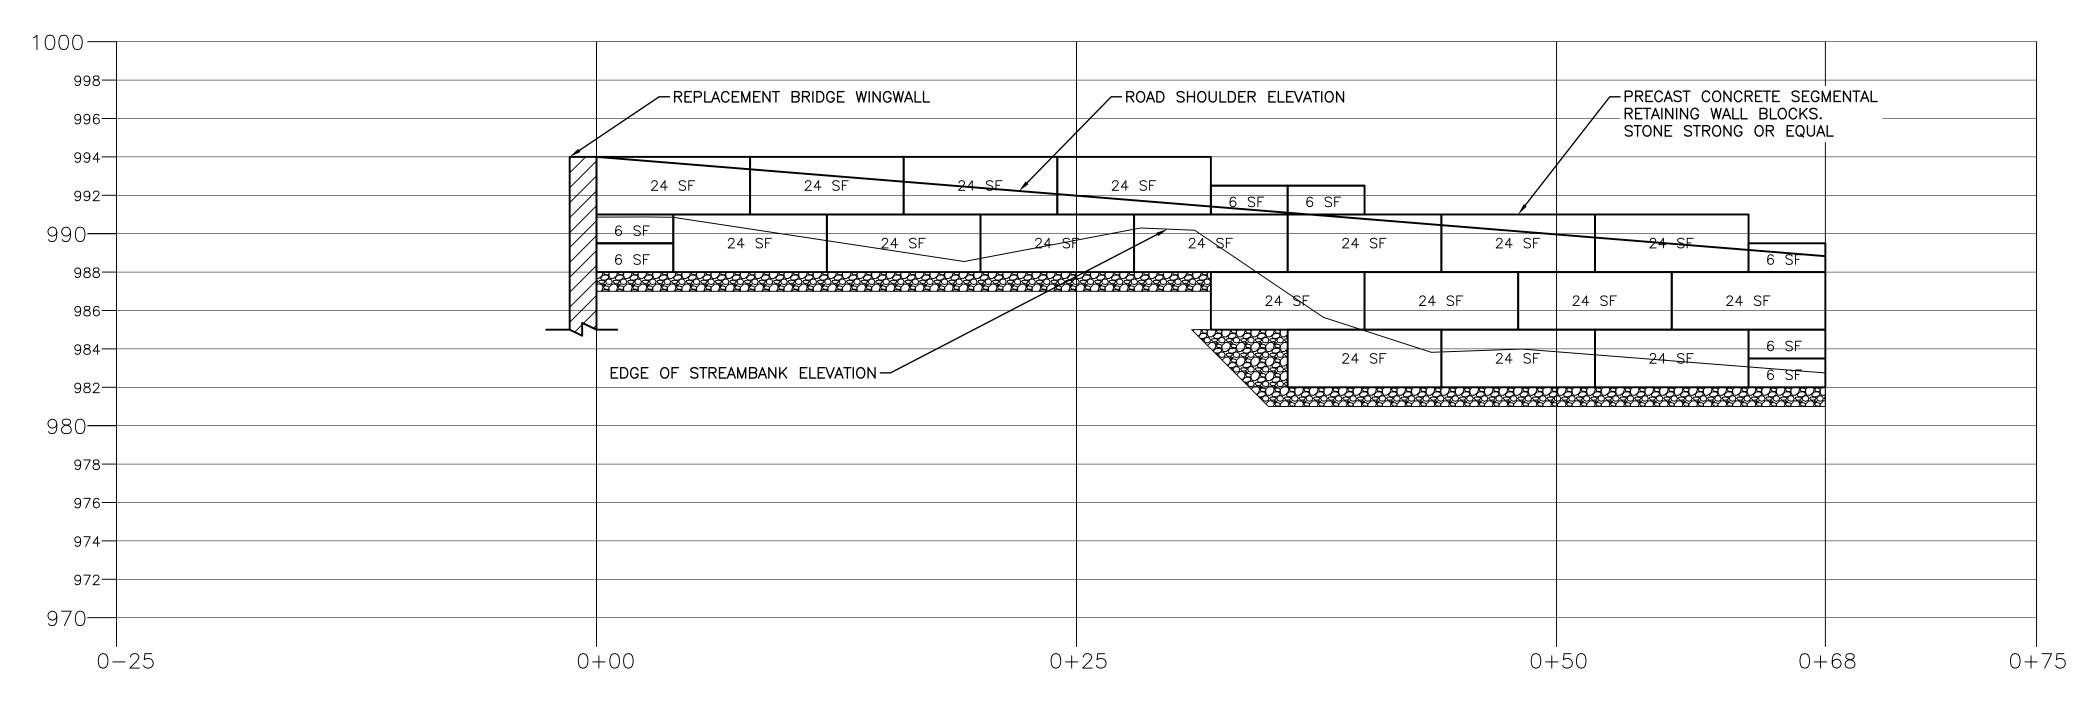



PROFILE VIEW

HORIZONTAL SCALE: 1" = 5'

VERTICAL SCALE: 1" = 5'

VERTICAL EXAGERATION: 0

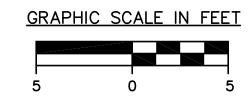

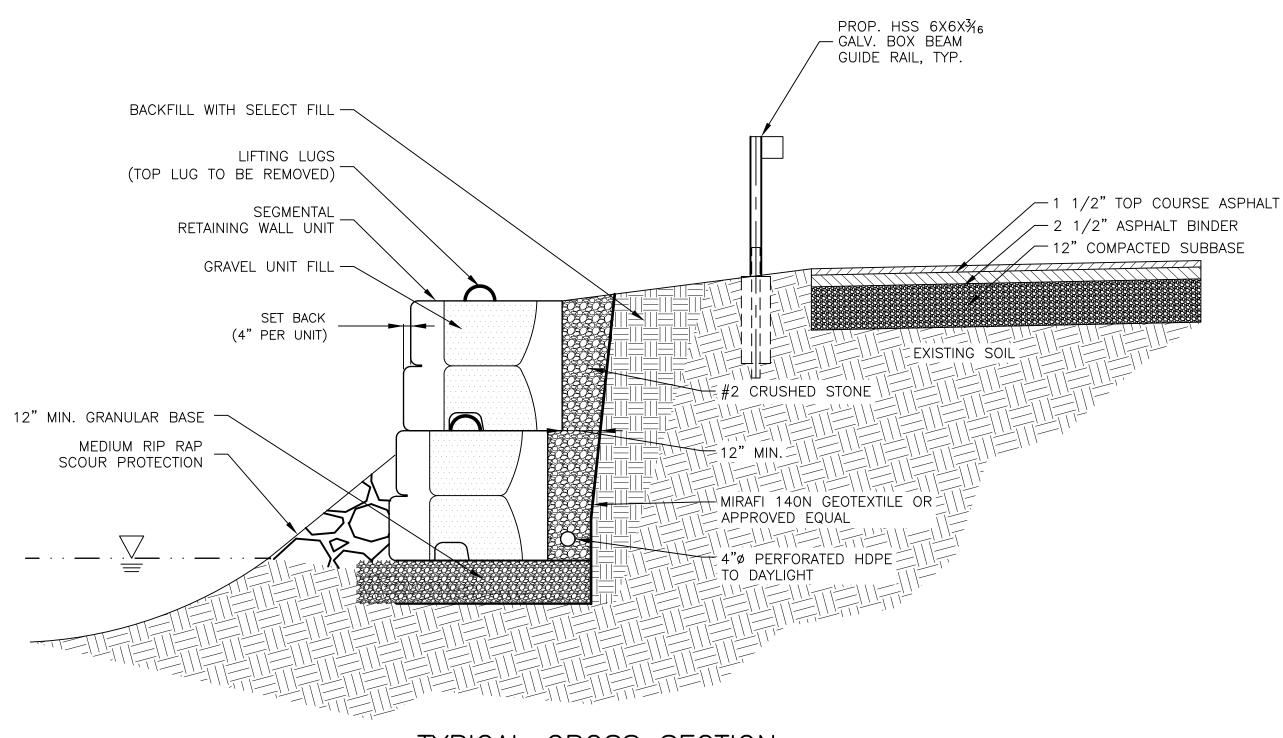

TYPICAL CROSS SECTION

NOT TO SCALE







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SEGMENTAL RETAINING WALL PLAN CONTRACT TS-166

PANTHERKILL BRIDGE REPLACEMENT NY RISING COMMUNITY RECONSTRUCTION PROGRAM NEW YORK STATE GOVERNORS OFFICE OF STORM RECOVERY

TOWN (OF SHANDAKEN	ULSTER COL	JNTY	NEW YORK	
DATE	REVISION RECORD	BRINNIE	R & LA	RIOS, P.C.	
		ENGINEERS & LAND SURVEYORS 67 MAIDEN LANE KINGSTON, N.Y. Phone: 845-338-7622 Fax: 845-338-7660			
		SCALE AS SHOWN	DATE JULY 201 DWG CHK RJS DN	C7	



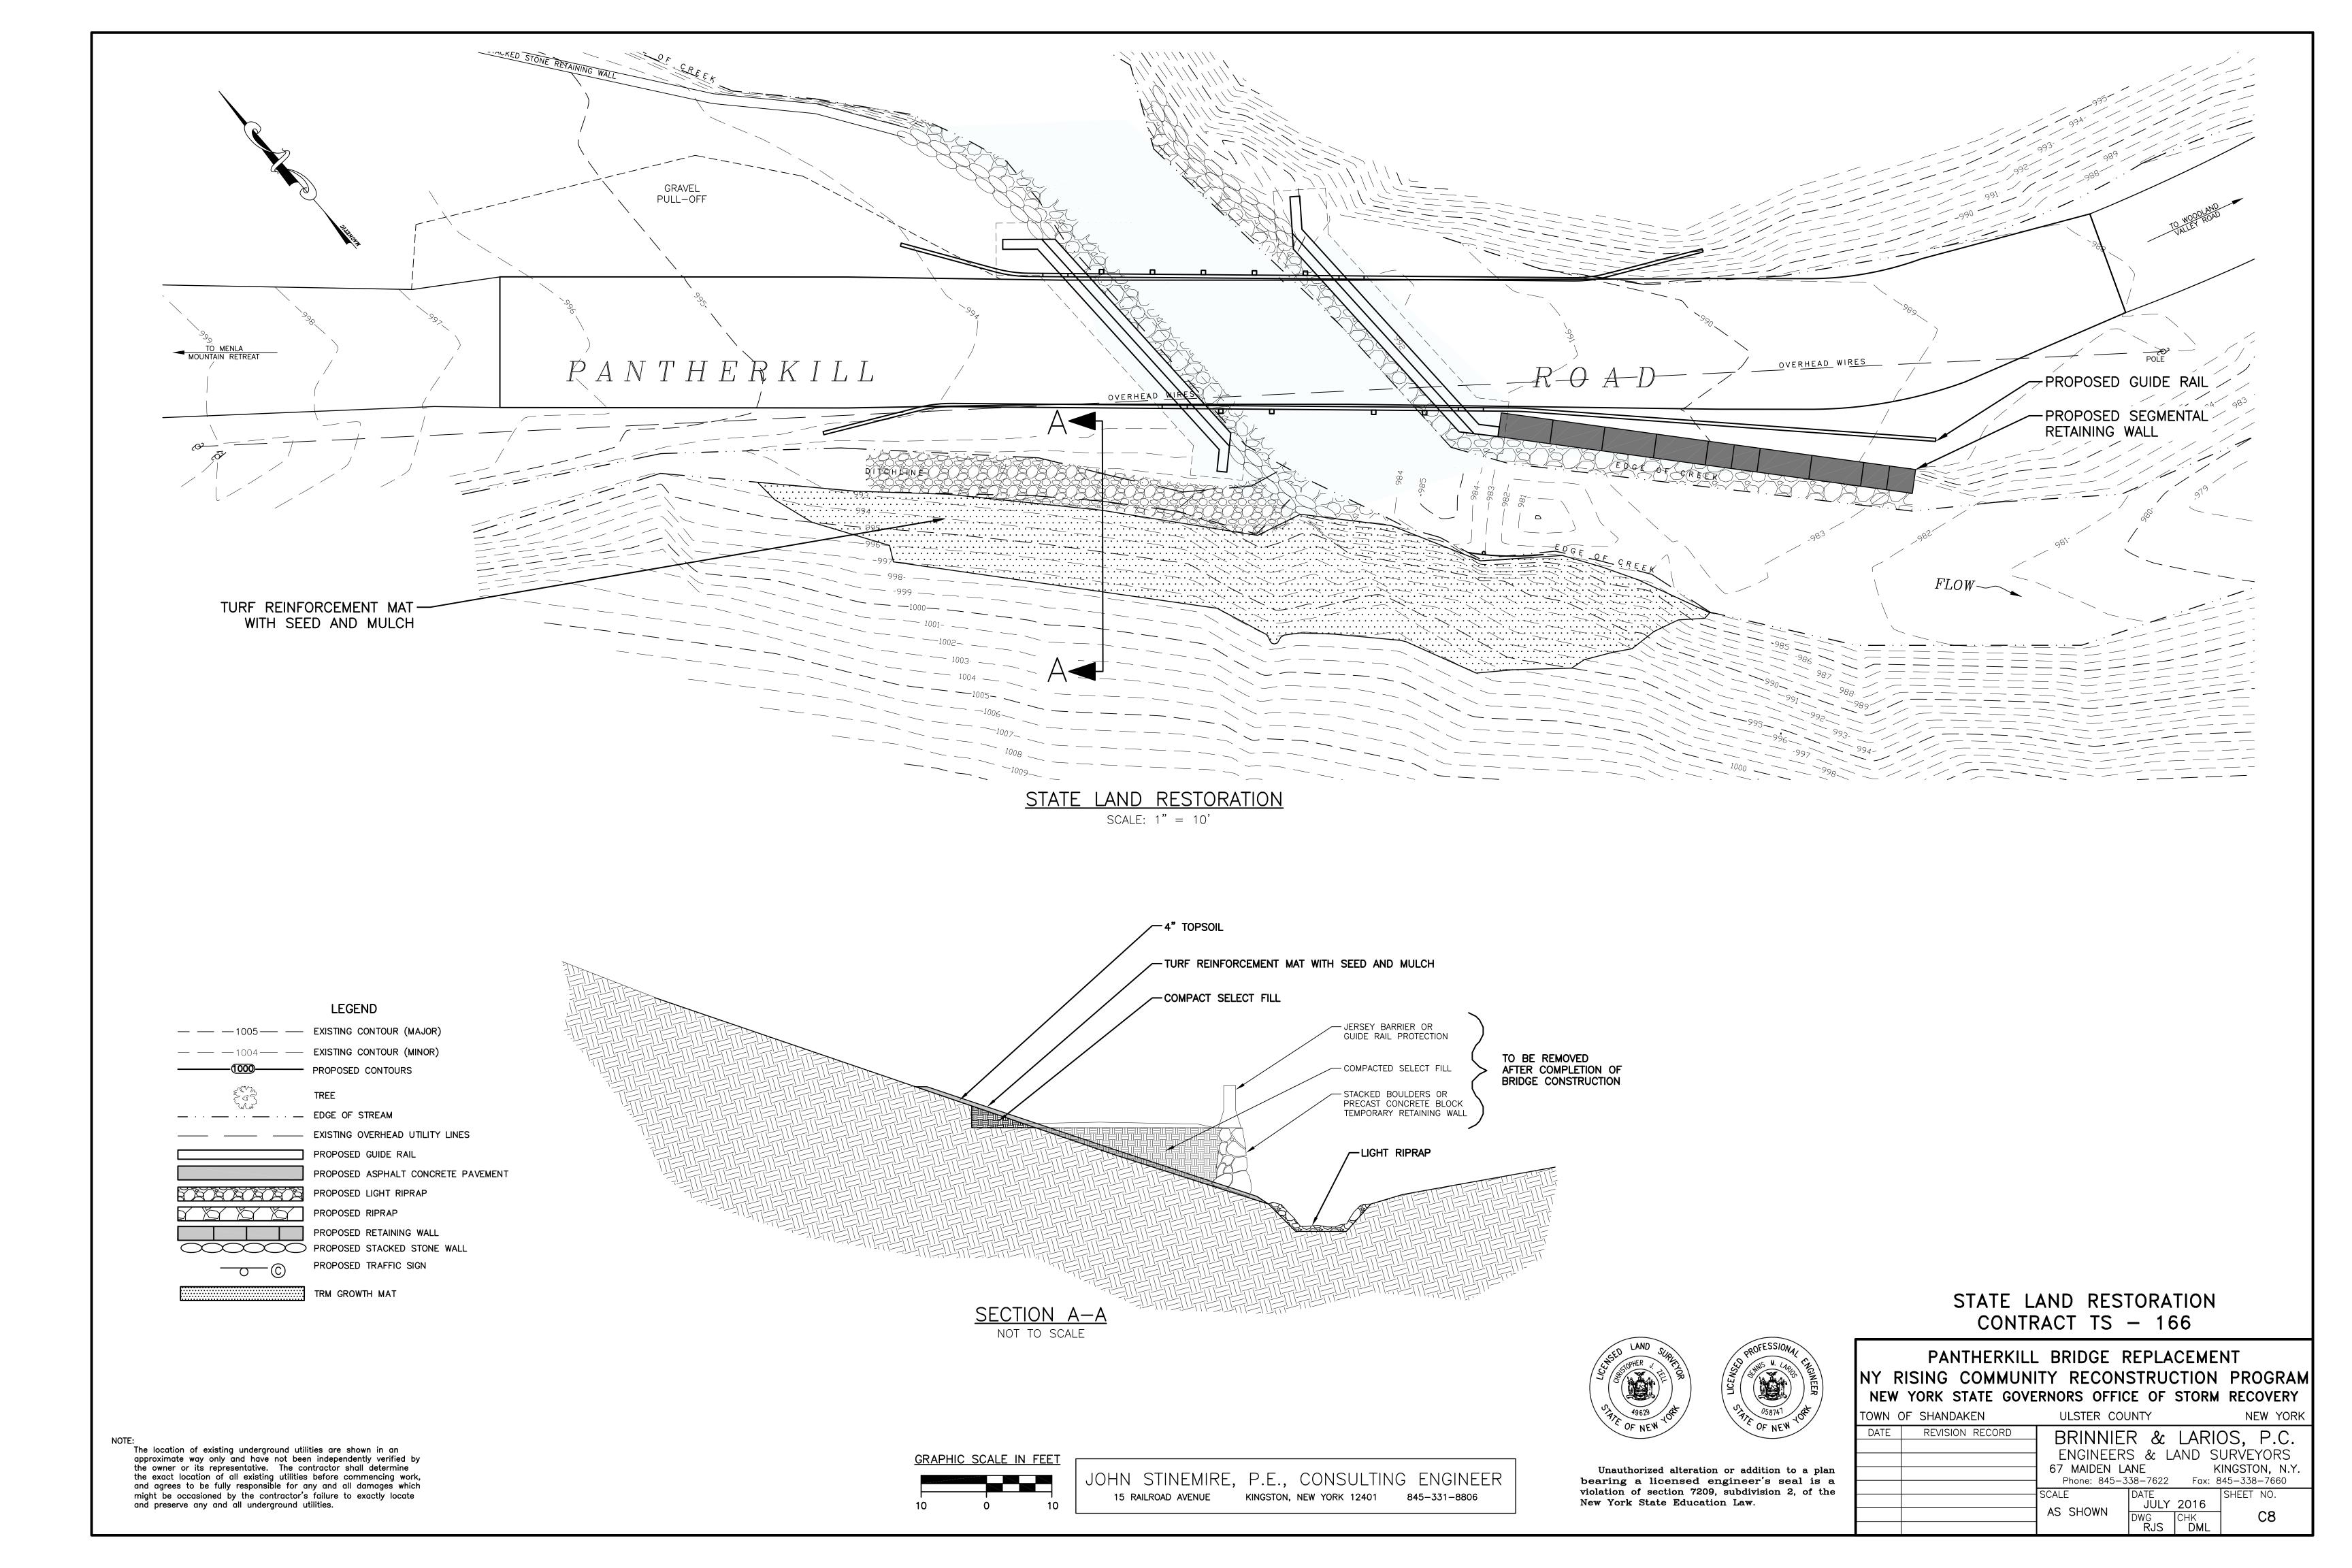

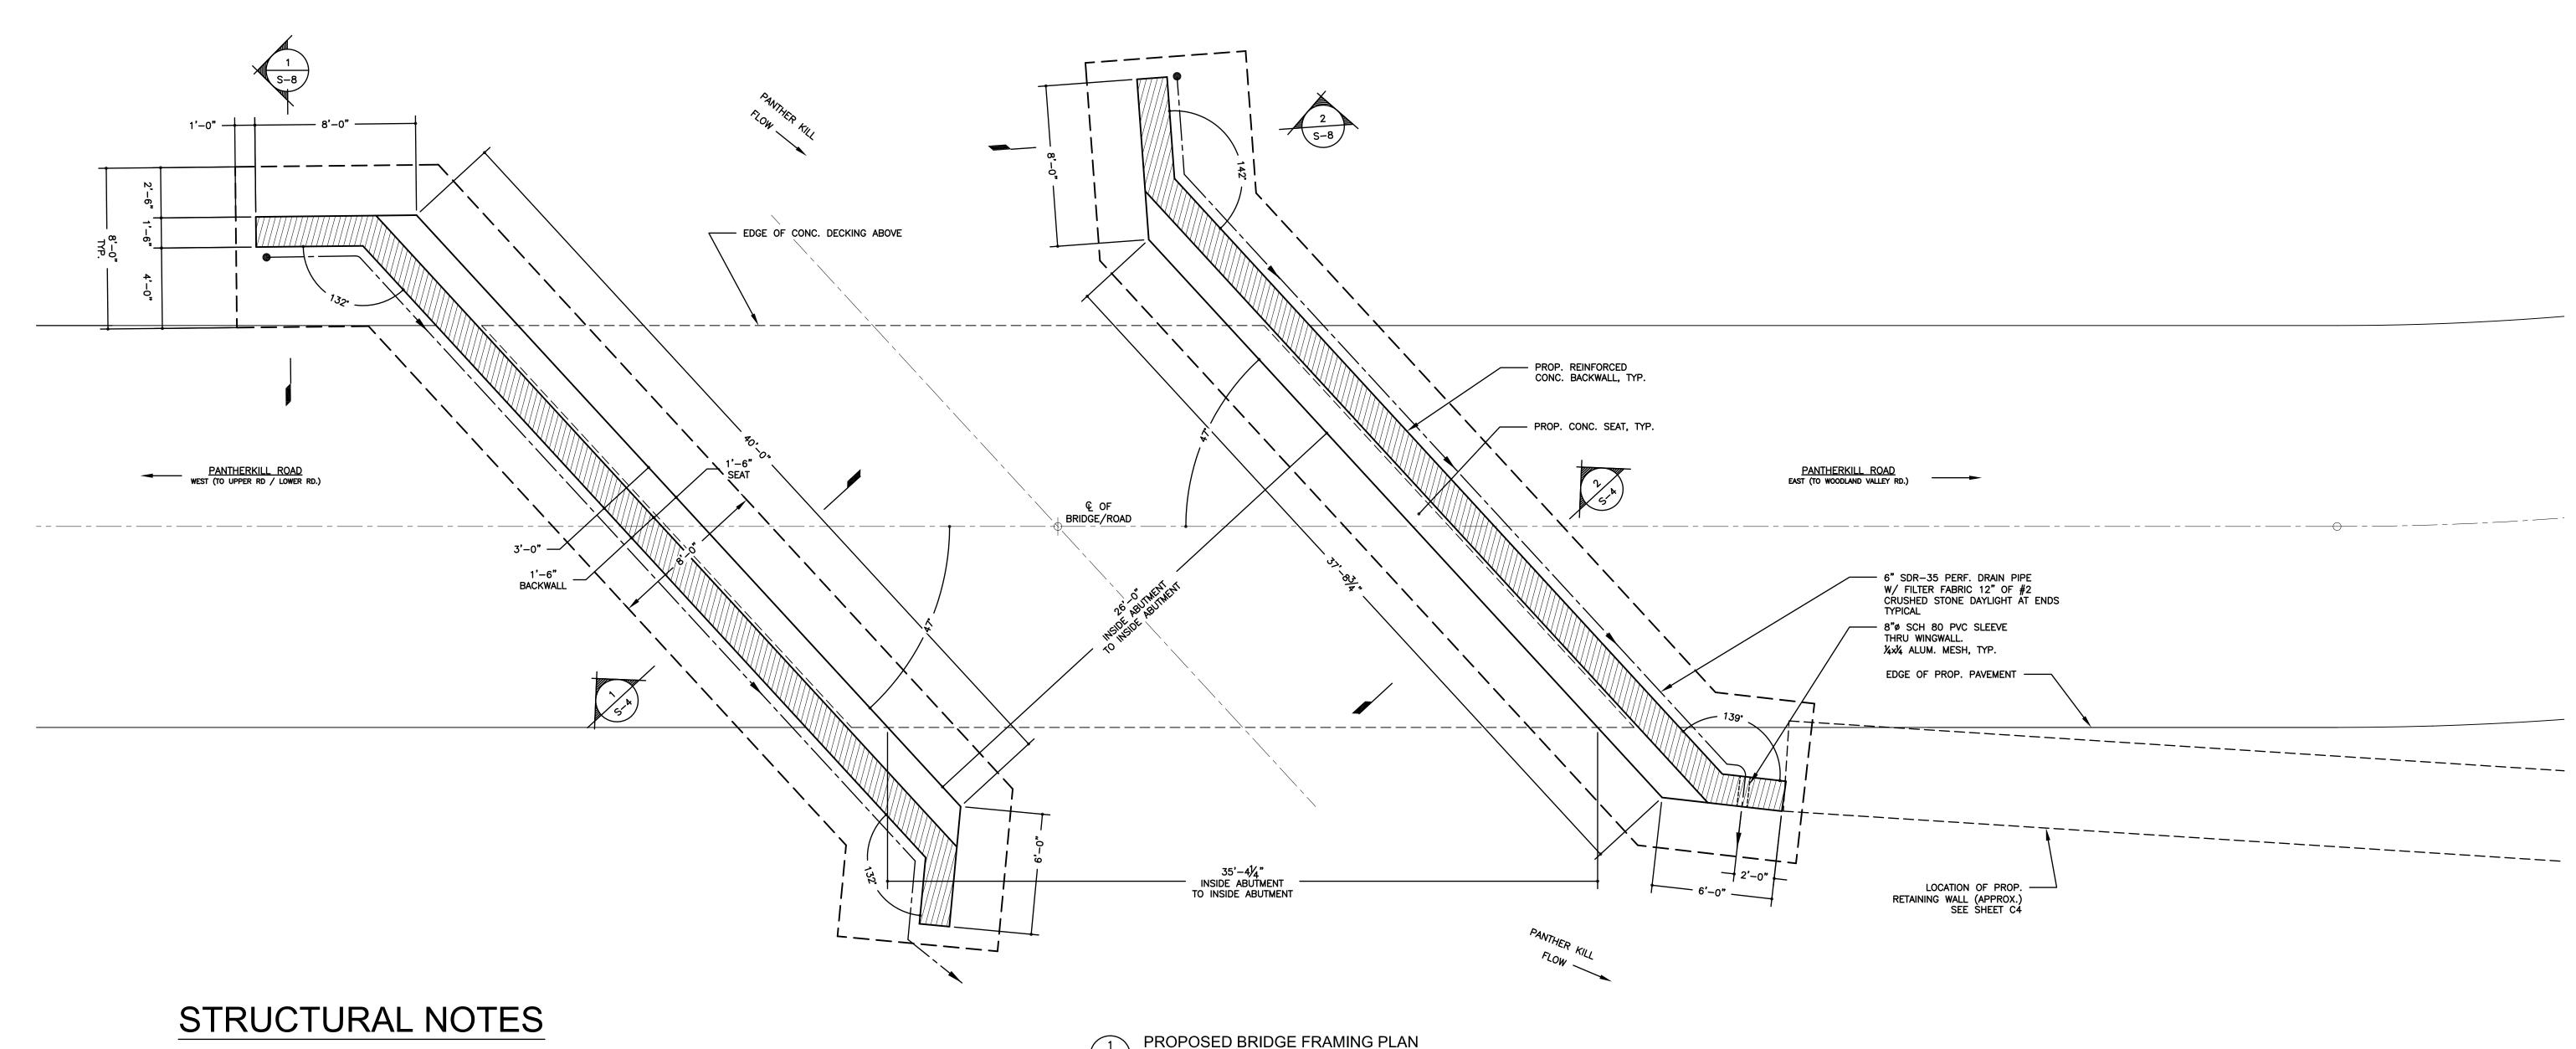GENERAL NOTES:

I. ALL DIMENSIONS SHALL BE VERIFIED IN FIELD BY CONTRACTOR WITH ALL DISCREPANCIES REPORTED TO THE ENGINEER. 2. DO NOT CHANGE SIZE NOR SPACING OF STRUCTURAL ELEMENTS.

3. DETAILS SHOWN ARE TYPICAL; SIMILAR DETAILS APPLY TO SIMILAR CONDITIONS UNLESS OTHERWISE NOTED. 4. THESE DRAWINGS DO NOT INCLUDE NECESSARY COMPONENTS FOR

CONSTRUCTION SAFETY. 5. CONTRACTOR SHALL DETERMINE EXACT LOCATION OF EXISTING UTILITIES, IF ANY, BEFORE COMMENCING WORK. HE AGREES TO BE FULLY

BY HIS FAILURE TO EXACTLY LOCATE AND PRESERVE UNDERGROUND 6. INCORRECTLY FABRICATED, DAMAGED, OR OTHERWISE MISFITTING OR NONCONFORMING MATERIALS OR CONDITIONS SHALL BE REPORTED TO THE OWNER PRIOR TO REMEDIAL OR CORRECTIVE ACTION. ANY SUCH ACTION

RESPONSIBLE FOR ANY AND ALL DAMAGES WHICH MIGHT BE OCCASIONED

7. EACH CONTRACTOR SHALL COOPERATE WITH THE OWNER'S REPRESENTATIVE, AND COORDINATE HIS WORK WITH THE WORK OF OTHERS. 8. VERIFY SIZE AND LOCATION OF OPENINGS. FOR DIMENSIONS AND OPENINGS NOT SHOWN, SEE MECHANICAL, ELECTRICAL, AND ARCHITECTURAL DRAWINGS.

DESIGN DATA:

STRUCTURAL DESIGN HAS BEEN PERFORMED IN ACCORDANCE WITH THE FOLLOWING CODES AND STANDARDS:

A) AISC, MANUAL OF STEEL CONSTRUCTION, ALLOWABLE STRESS DESIGN, 9TH ED.

CONCRETE FLOOR: = 12.5 PSF PER INCH THICKNESS OF $CONC. \times 7" = 87.50 PSF$

SHALL REQUIRE APPROVAL.

I. TRAFFIC LOADS H20 TRUCK LOADING IN ACCORDANCE WITH AASHTO STANDARDS 2. DEAD LOADS

PAVEMENT = 25 PSF. FUTURE WEARING COURSE = 25 PSF.

and preserve any and all underground utilities.

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OF STRUCTURAL ELEMENTS AT AN AMBIENT TEMPERATURE OF 68 DEGREES FAHRENHEIT

ABBREVIATIONS

A.O.B.E.

..ANCHOR BOLT ..AS ORDERED BY ENGINEER ...BASE PLATE

COLS.. ...COLUMNS ..DITTO ...EVERY OTHER ..EACH WAY ...EXPANSION

...FOUNDATION FDN. F.G... ...FINISHED GRADE ...HEADER

..HOLLOW STRUCTURAL SHAPE (A.I.S.C.) ...LONG LEG VERTICAL

..POWDER ACTUATED FASTENER ..PRE-CAST ...PERFORATED


...PLATE ..REINFORCED CONCRETE ...REINFORCEMENT ...SELF-LEVELING

..SHORT LEG VERTICAL S.O.G. ..SLAB ON GRADE ..STEEL ..TOP OF FOOTING

T/FTG... T/WALL ...TOP OF WALL ..TEMPERATURE AND SHRINKAGE T&S...

U.N.O.. ..WALL CONTROL JOINT

..UNLESS NOTED OTHERWISE

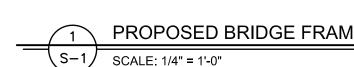

JOHN STINEMIRE, P.E., CONSULTING ENGINEER

15 RAILROAD AVENUE KINGSTON, NEW YORK 12401 845-331-8806






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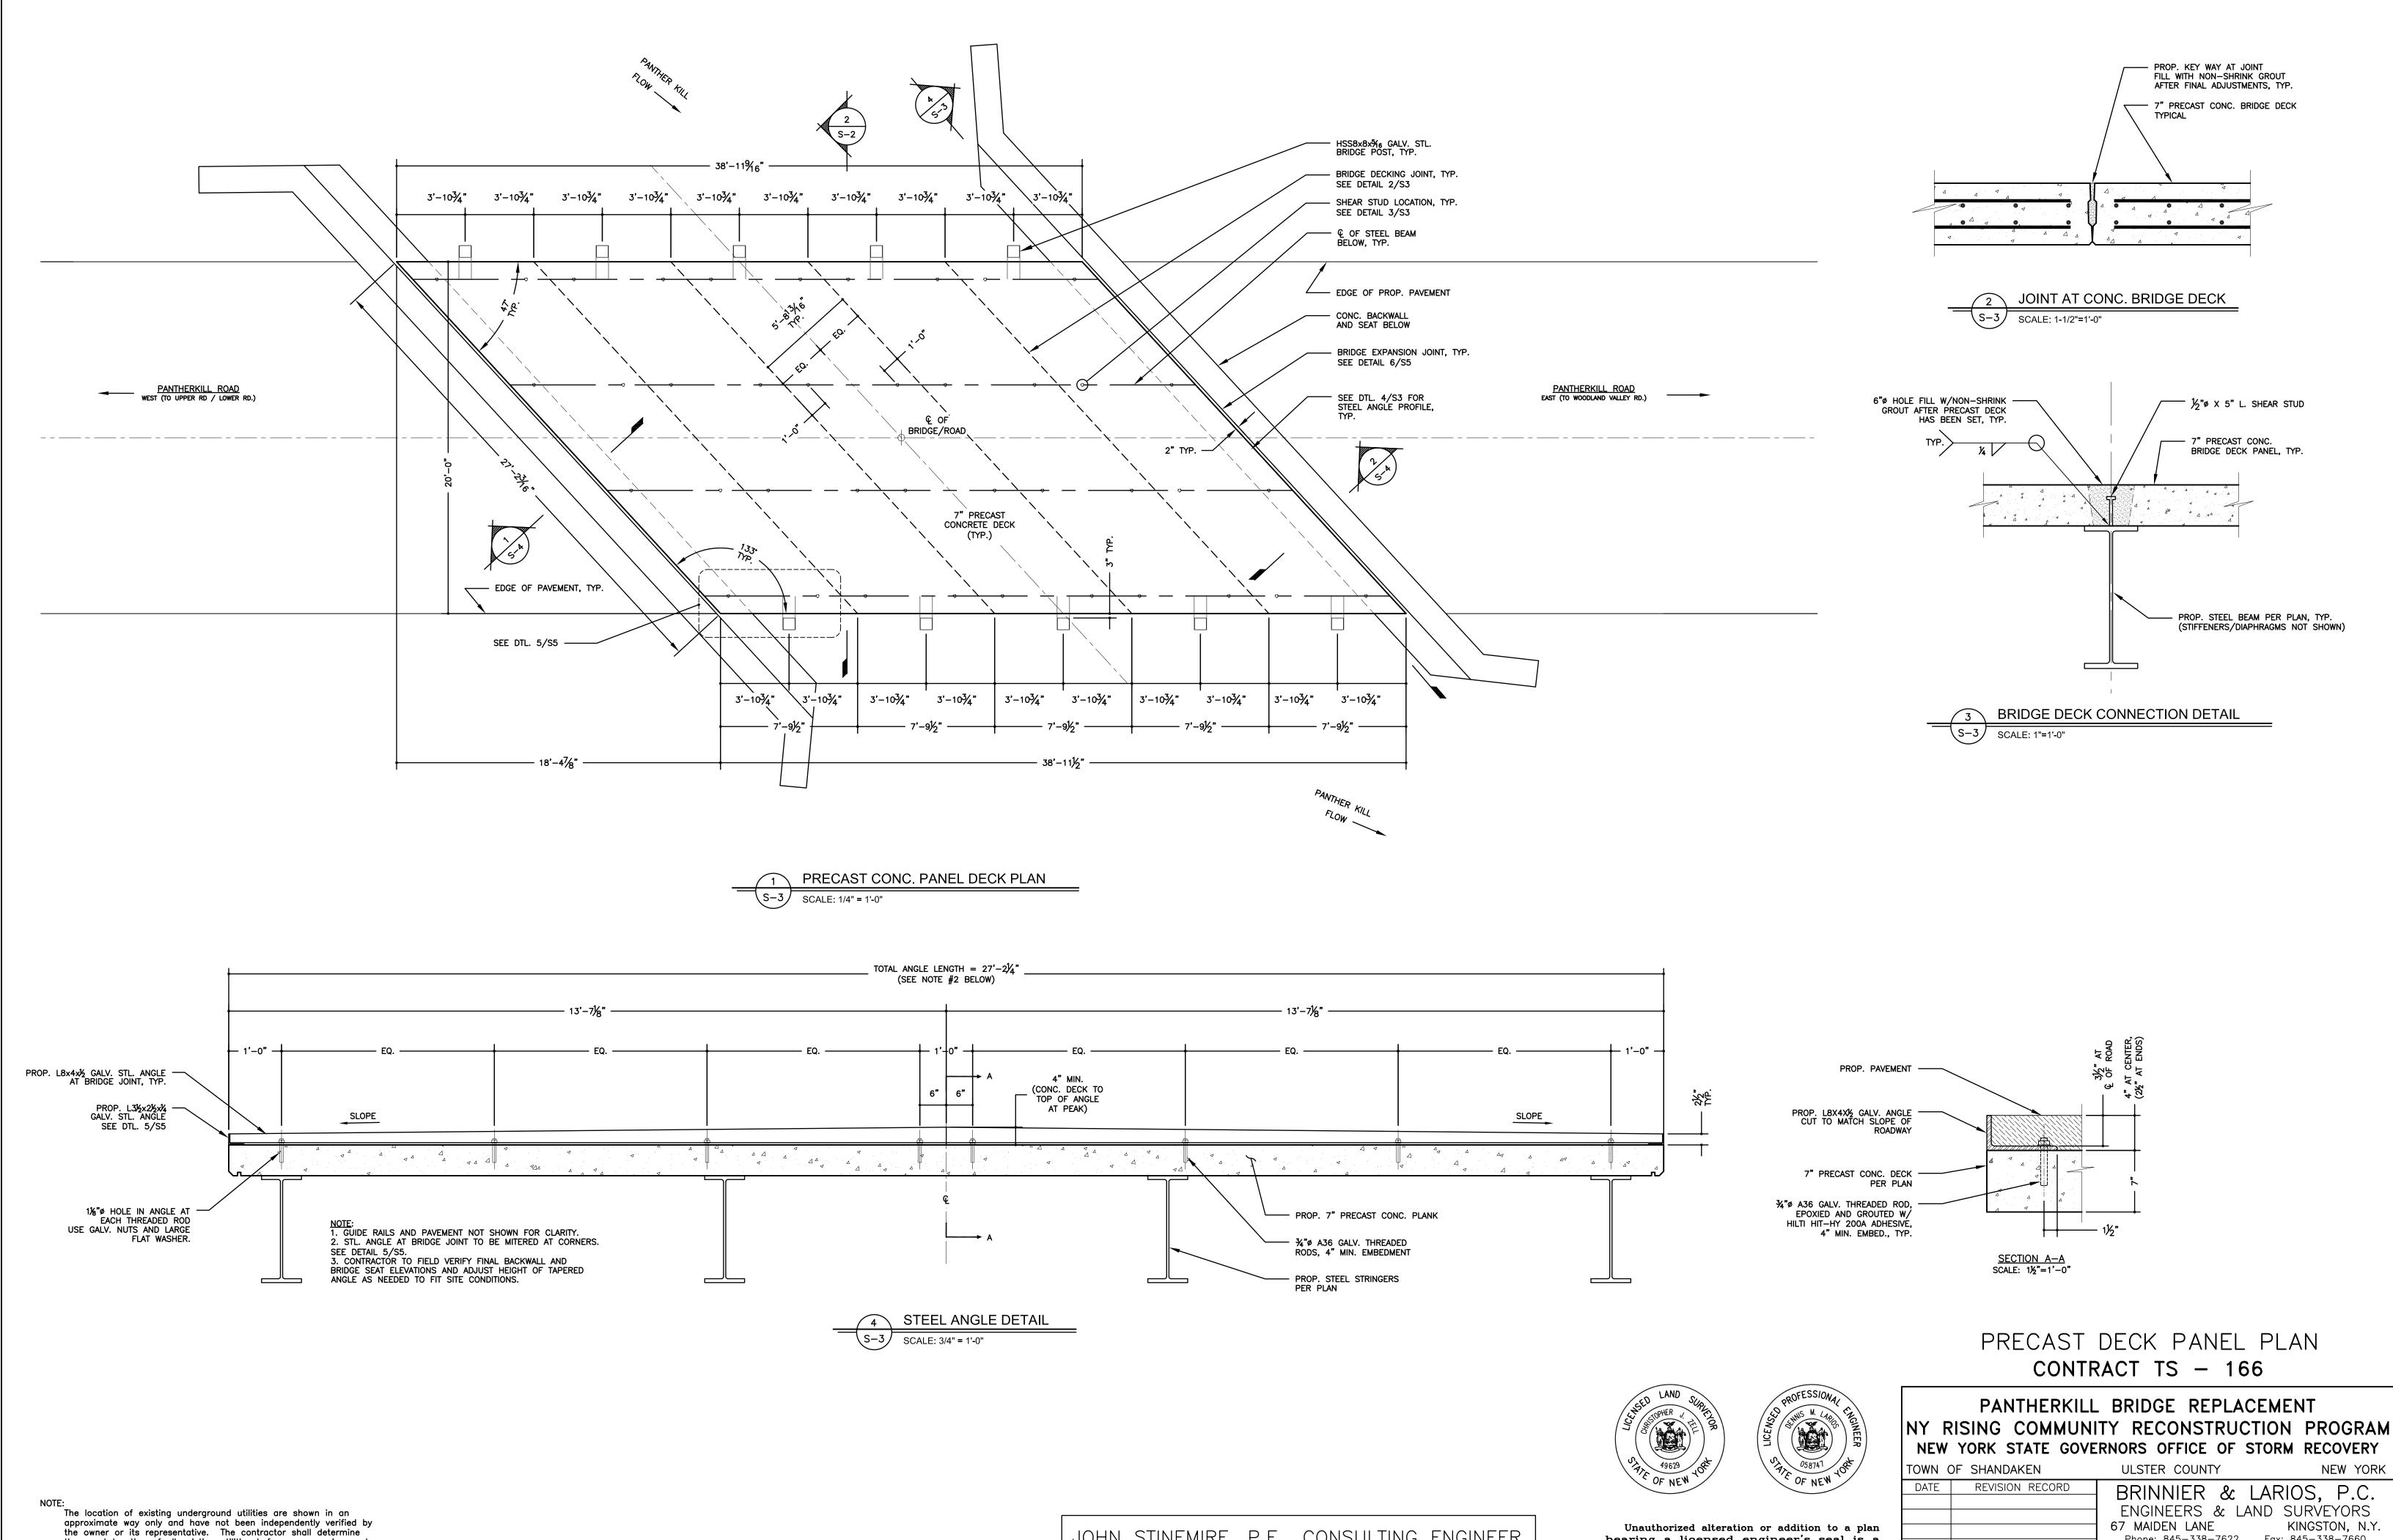
FOUNDATION PLAN & STRUCTURAL NOTES CONTRACT TS - 166

PANTHERKILL BRIDGE REPLACEMENT NY RISING COMMUNITY RECONSTRUCTION PROGRAM NEW YORK STATE GOVERNORS OFFICE OF STORM RECOVERY

TOWN OF SHANDAKEN ULSTER COUNTY NEW YORK DATE REVISION RECORD BRINNIER & LARIOS, P.C. ENGINEERS & LAND SURVEYORS 67 MAIDEN LANE KINGSTON, N.Y. Phone: 845-338-7622 Fax: 845-338-7660 SHEET NO. JULY 2016 AS SHOWN DWG CHK JH JES

NOTE: ALL DESIGN DIMENSIONS NOTED ON PLANS ARE BASED ON FABRICATION AND INSTALLATION



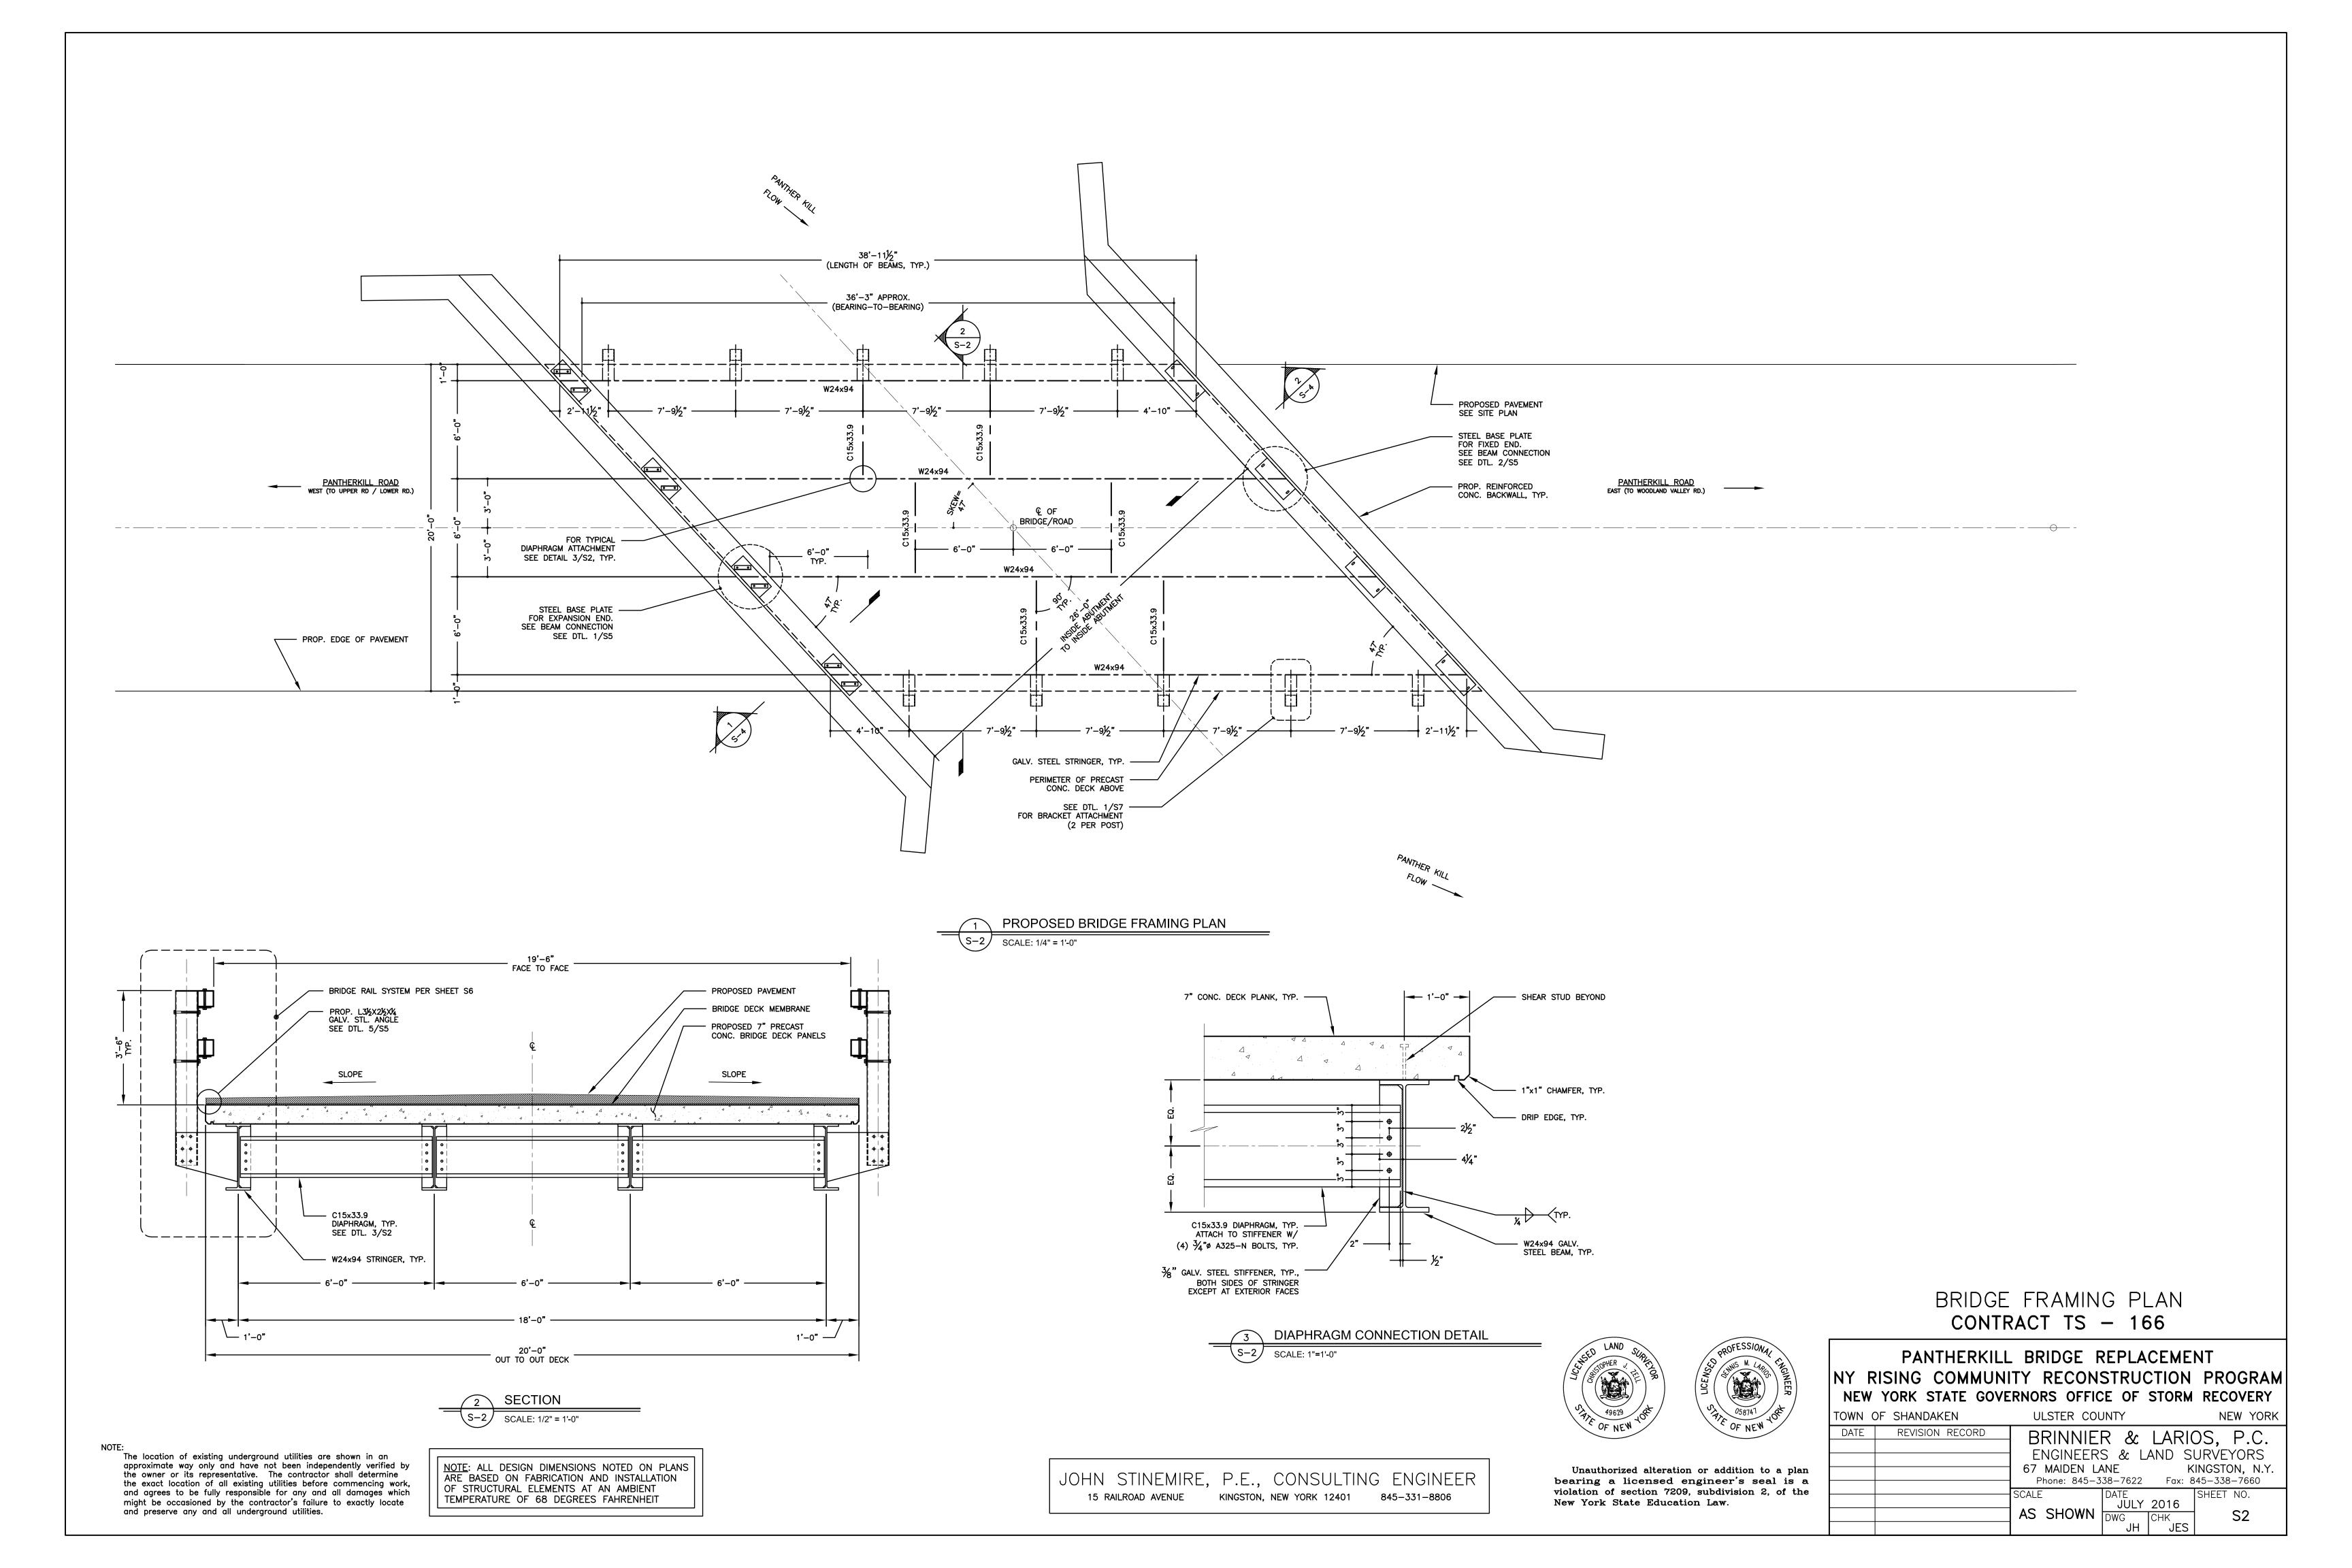


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TOWN OF	SHANDAKEN	ULSTER COL	א ו אוע		NEW YORK
DATE	REVISION RECORD	BRINNIE	R &	IARIO	OS P.C.
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		ENGINEERS & LAND SURVEYORS 67 MAIDEN LANE KINGSTON, N.Y. Phone: 845-338-7622 Fax: 845-338-7660			
		SCALE	DATE JULY		SHEET NO.
		AS SHOWN	DWG	ICHK	S3
			JH	JES	



BEDROCK

BOTTOM OF ALL FOOTINGS
TO BE 4'-0" MIN. BELOW
FINISHED GRADE
TYPICAL

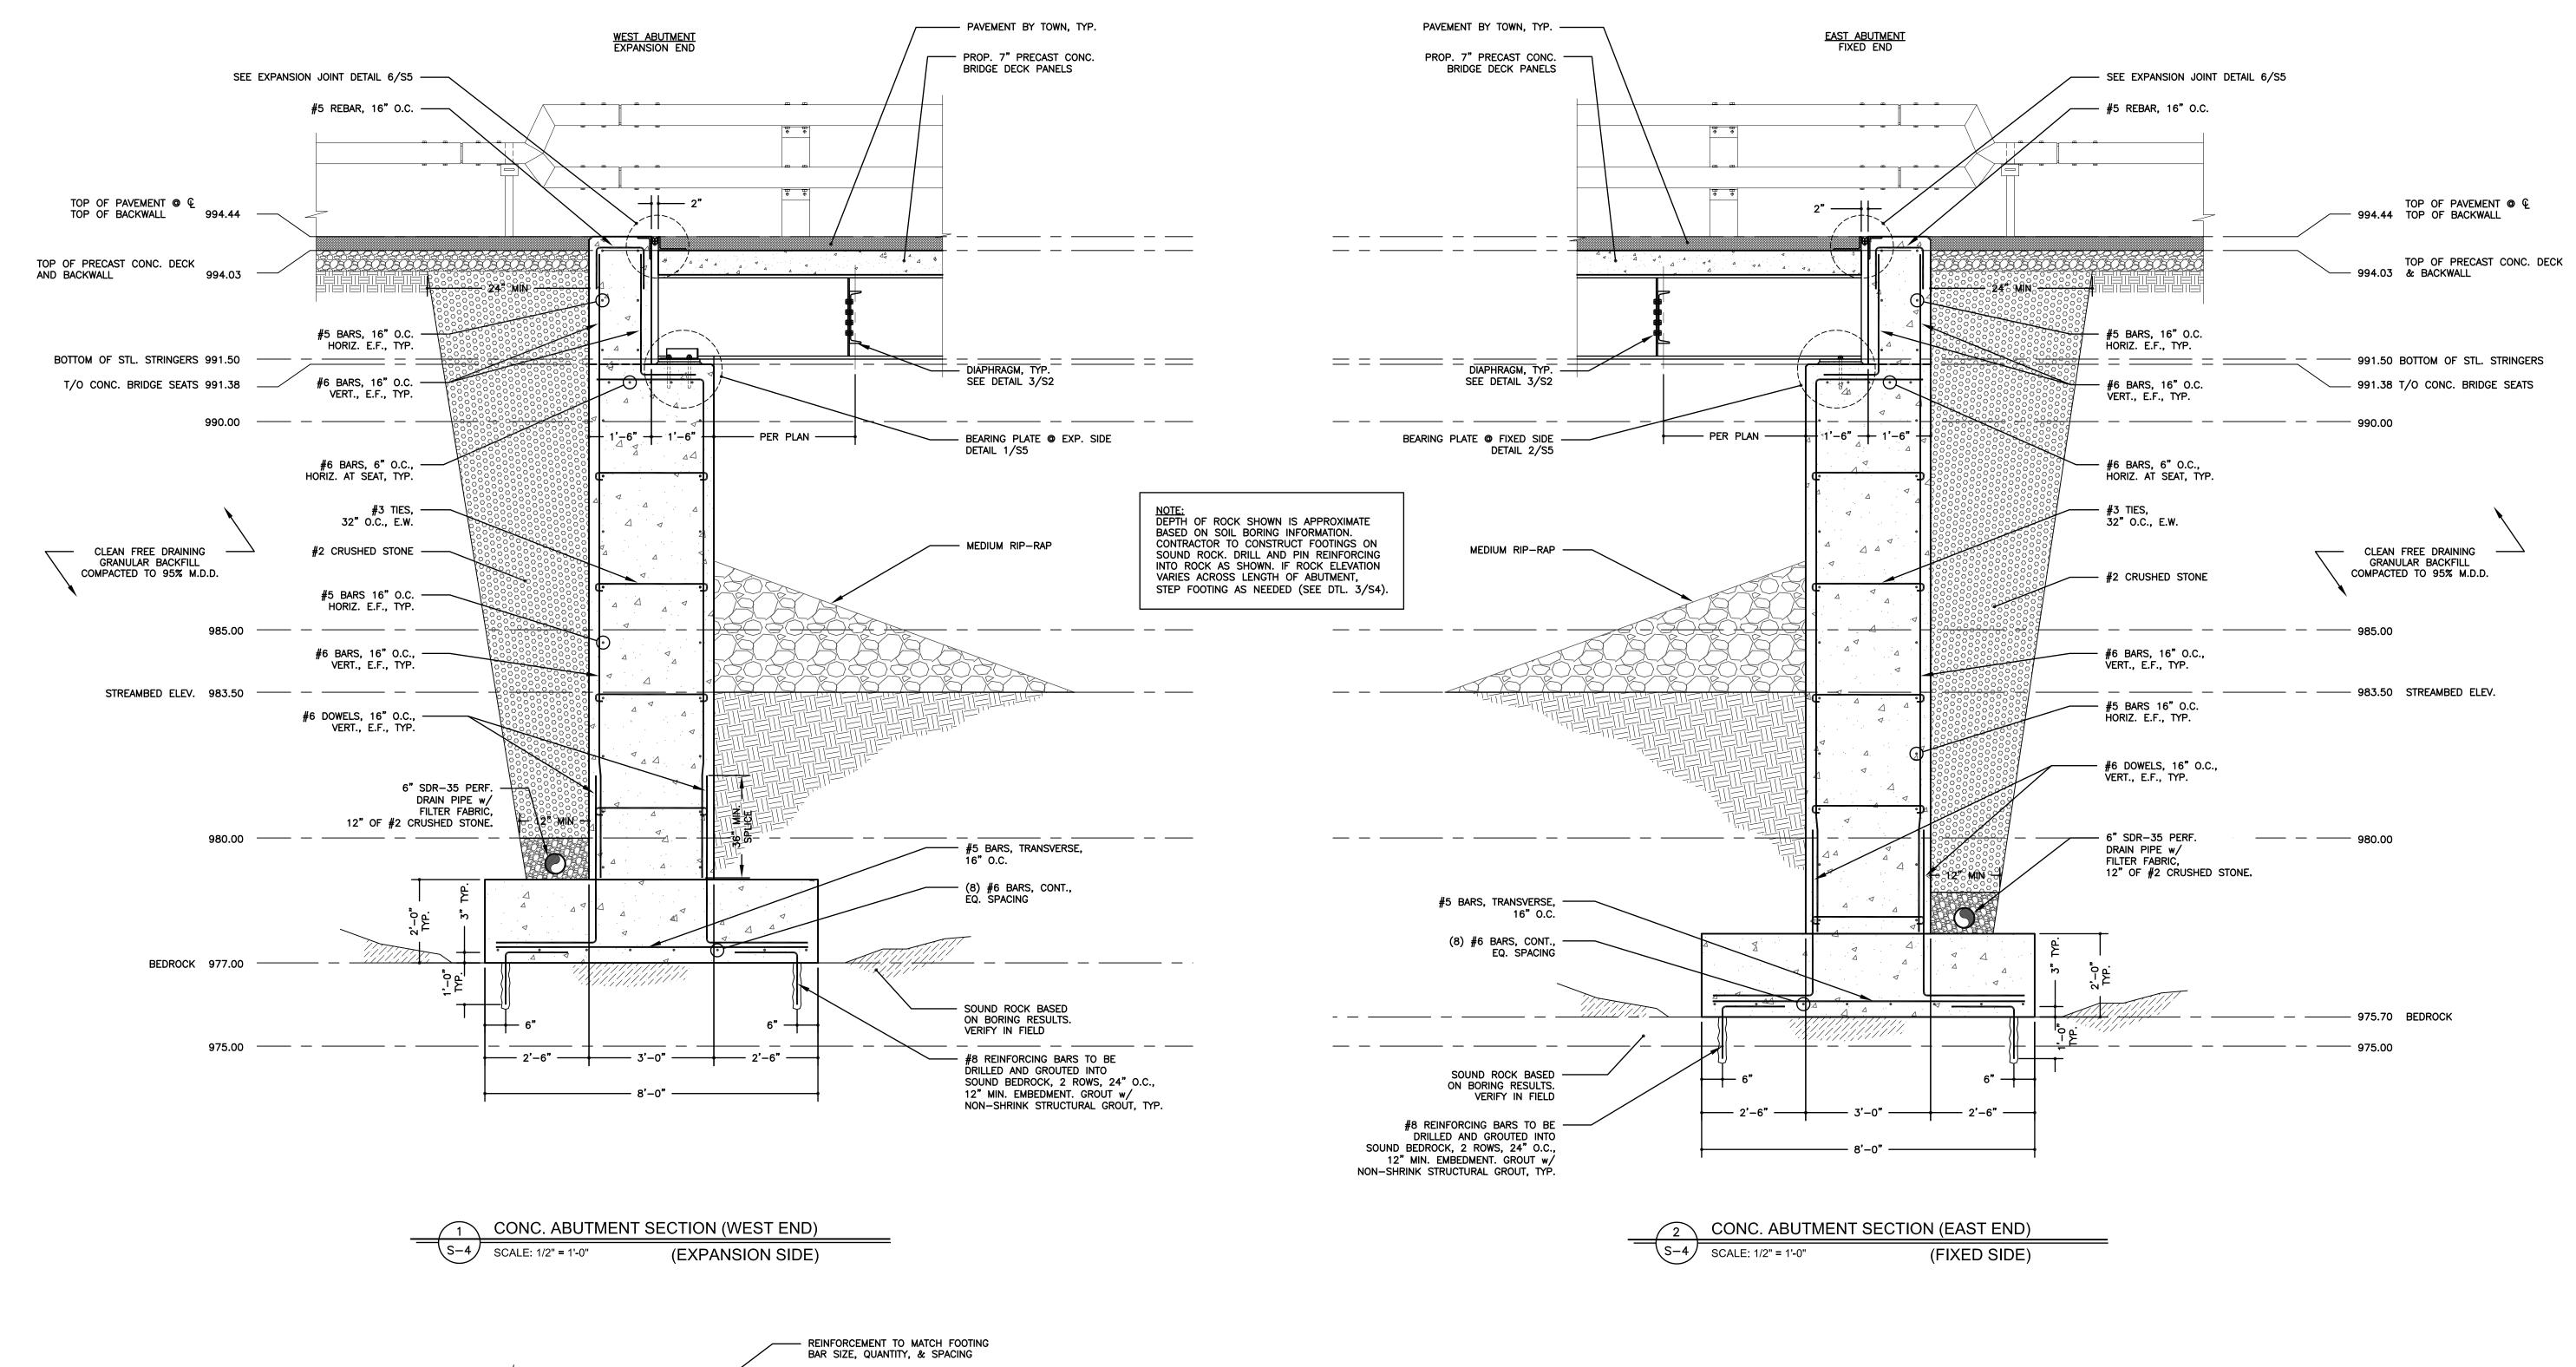30" LAP, TYP.

STEPPED FOOTING DETAIL

S-4 SCALE: 1/2" = 1'-0"





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PANTHERKILL BRIDGE REPLACEMENT NY RISING COMMUNITY RECONSTRUCTION PROGRAM NEW YORK STATE GOVERNORS OFFICE OF STORM RECOVERY

TOWN OF SHANDAKEN

DATE REVISION RECORD

BRINNIER & LARIOS, P.C.
ENGINEERS & LAND SURVEYORS
67 MAIDEN LANE KINGSTON, N.Y.
Phone: 845-338-7622 Fax: 845-338-7660


SCALE DATE JULY 2016
AS SHOWN
JH JES

S4

TE:

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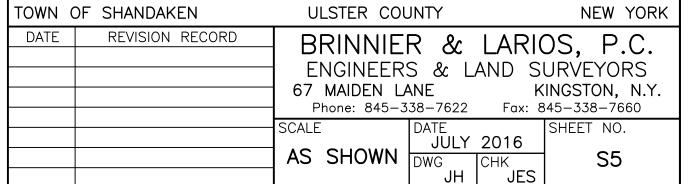
JOHN STINEMIRE, P.E., CONSULTING ENGINEER
15 RAILROAD AVENUE KINGSTON, NEW YORK 12401 845-331-8806

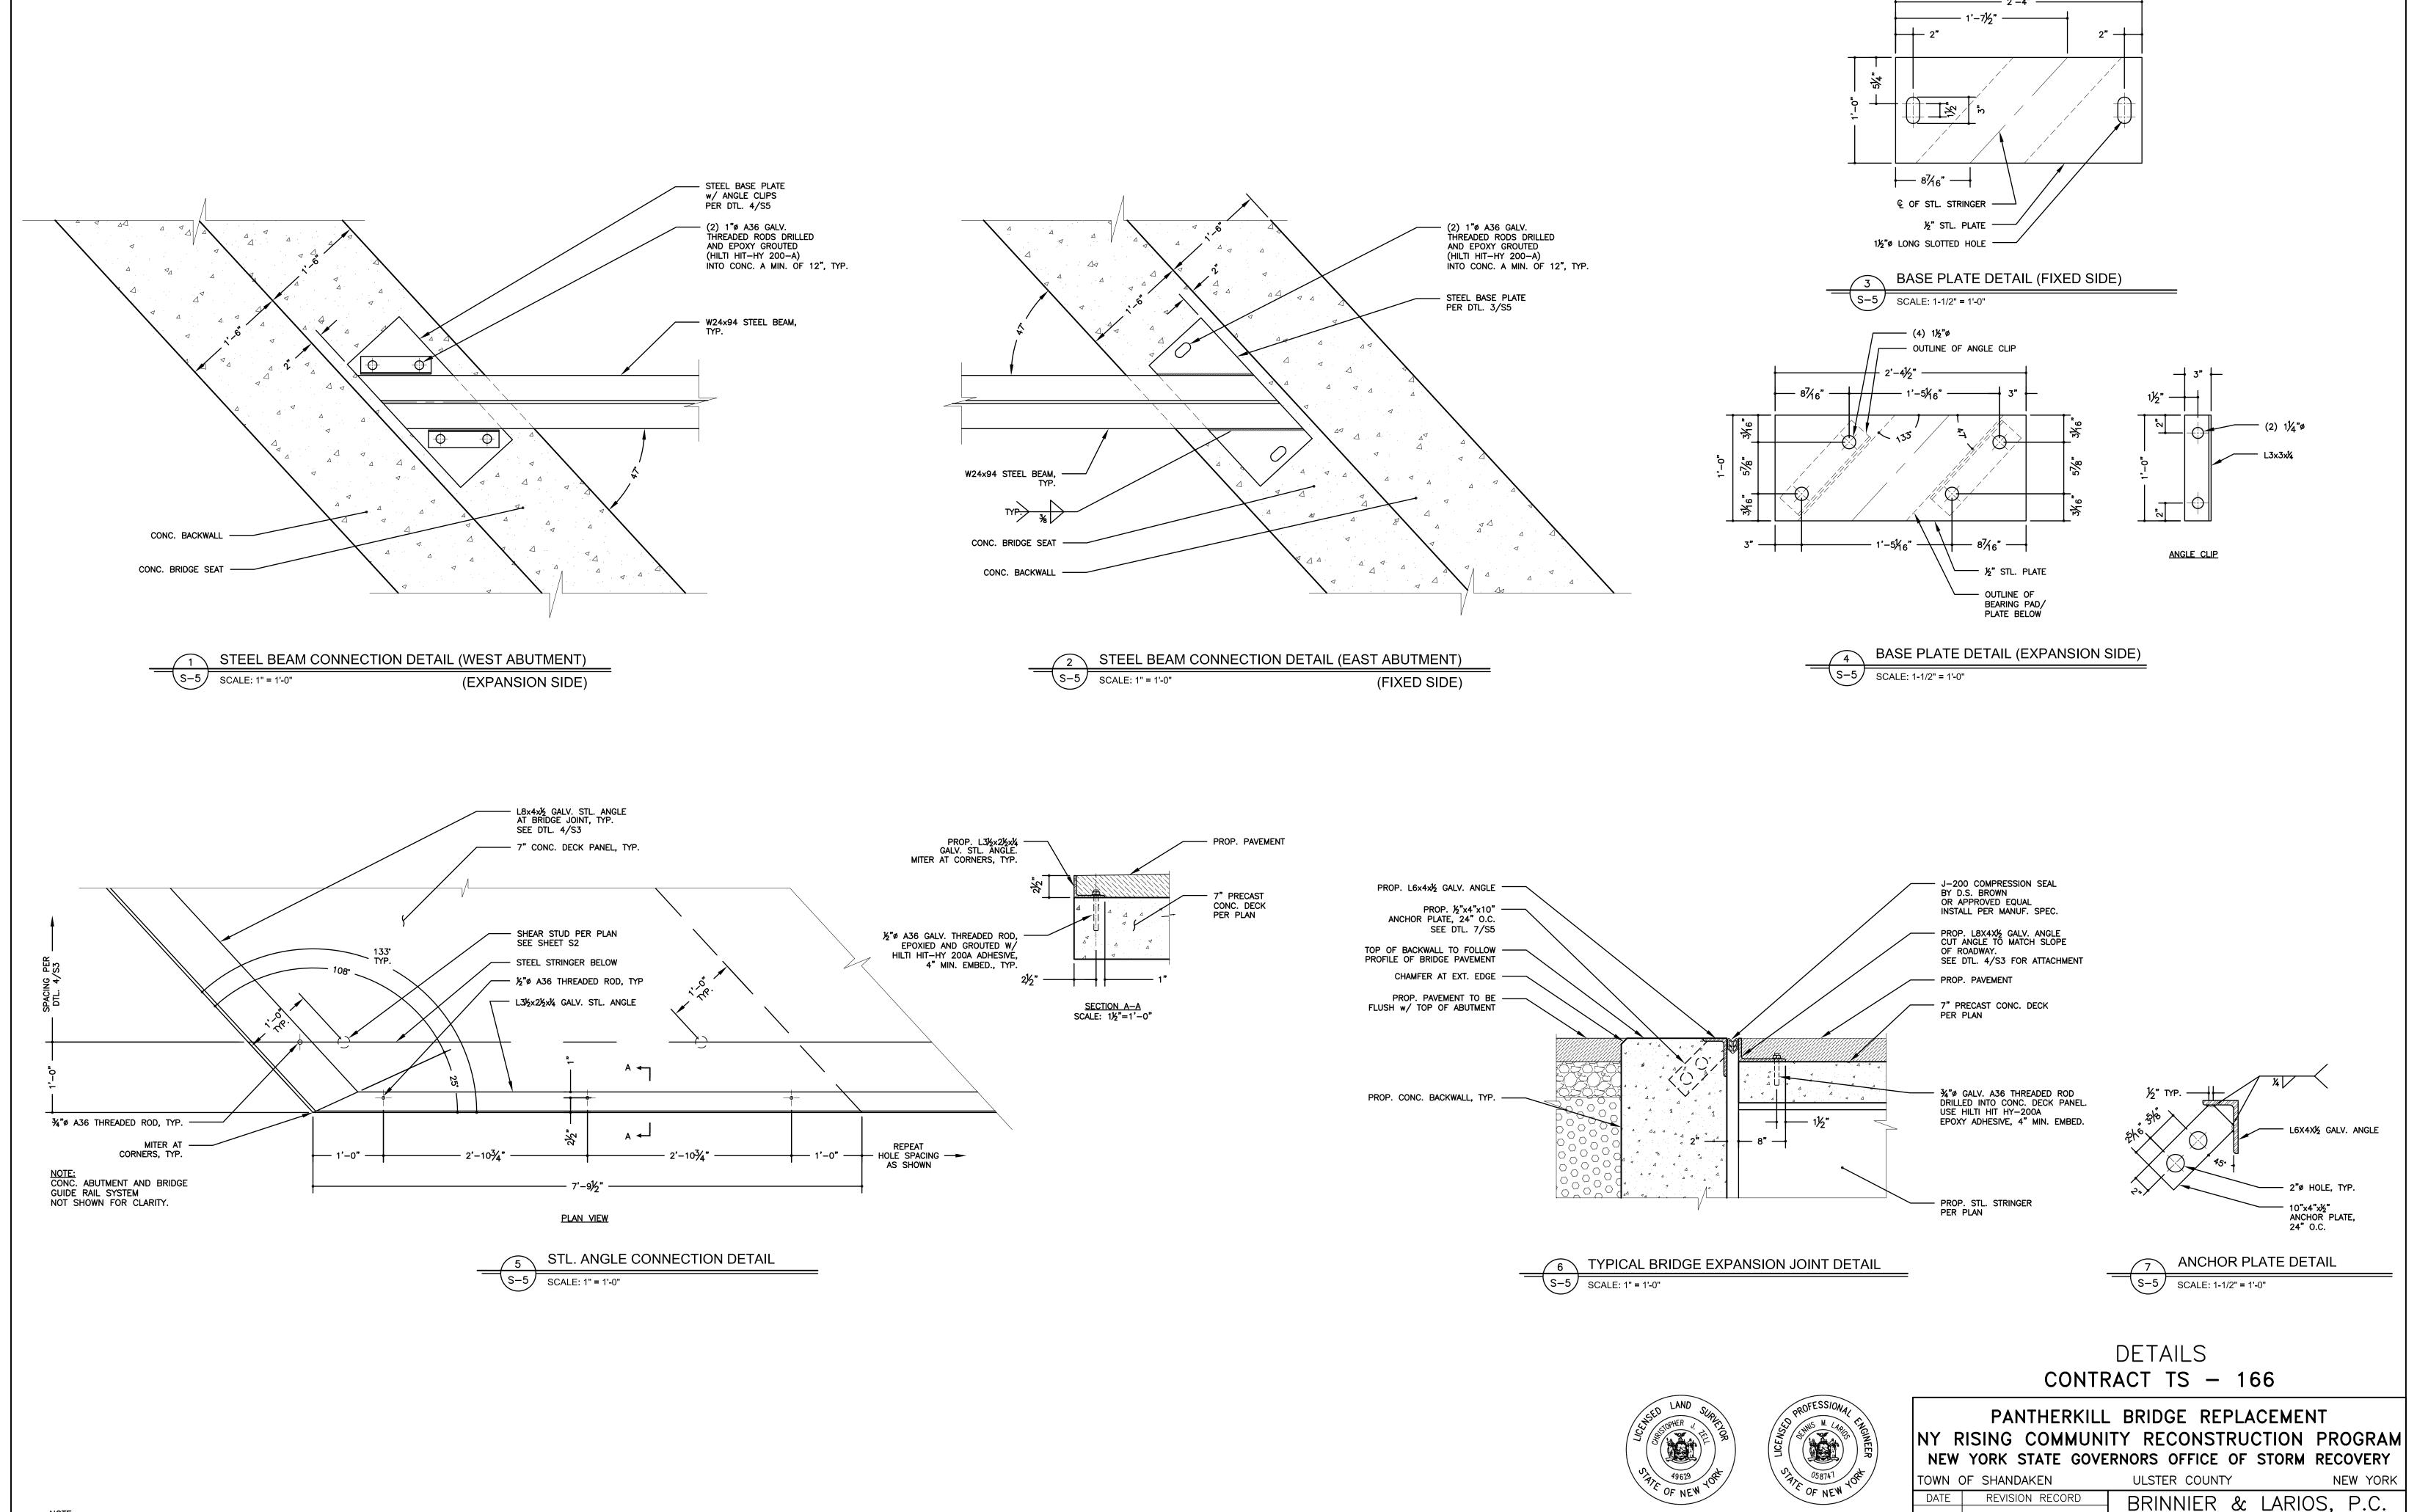



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15 RAILROAD AVENUE KINGSTON, NEW YORK 12401 845-331-8806





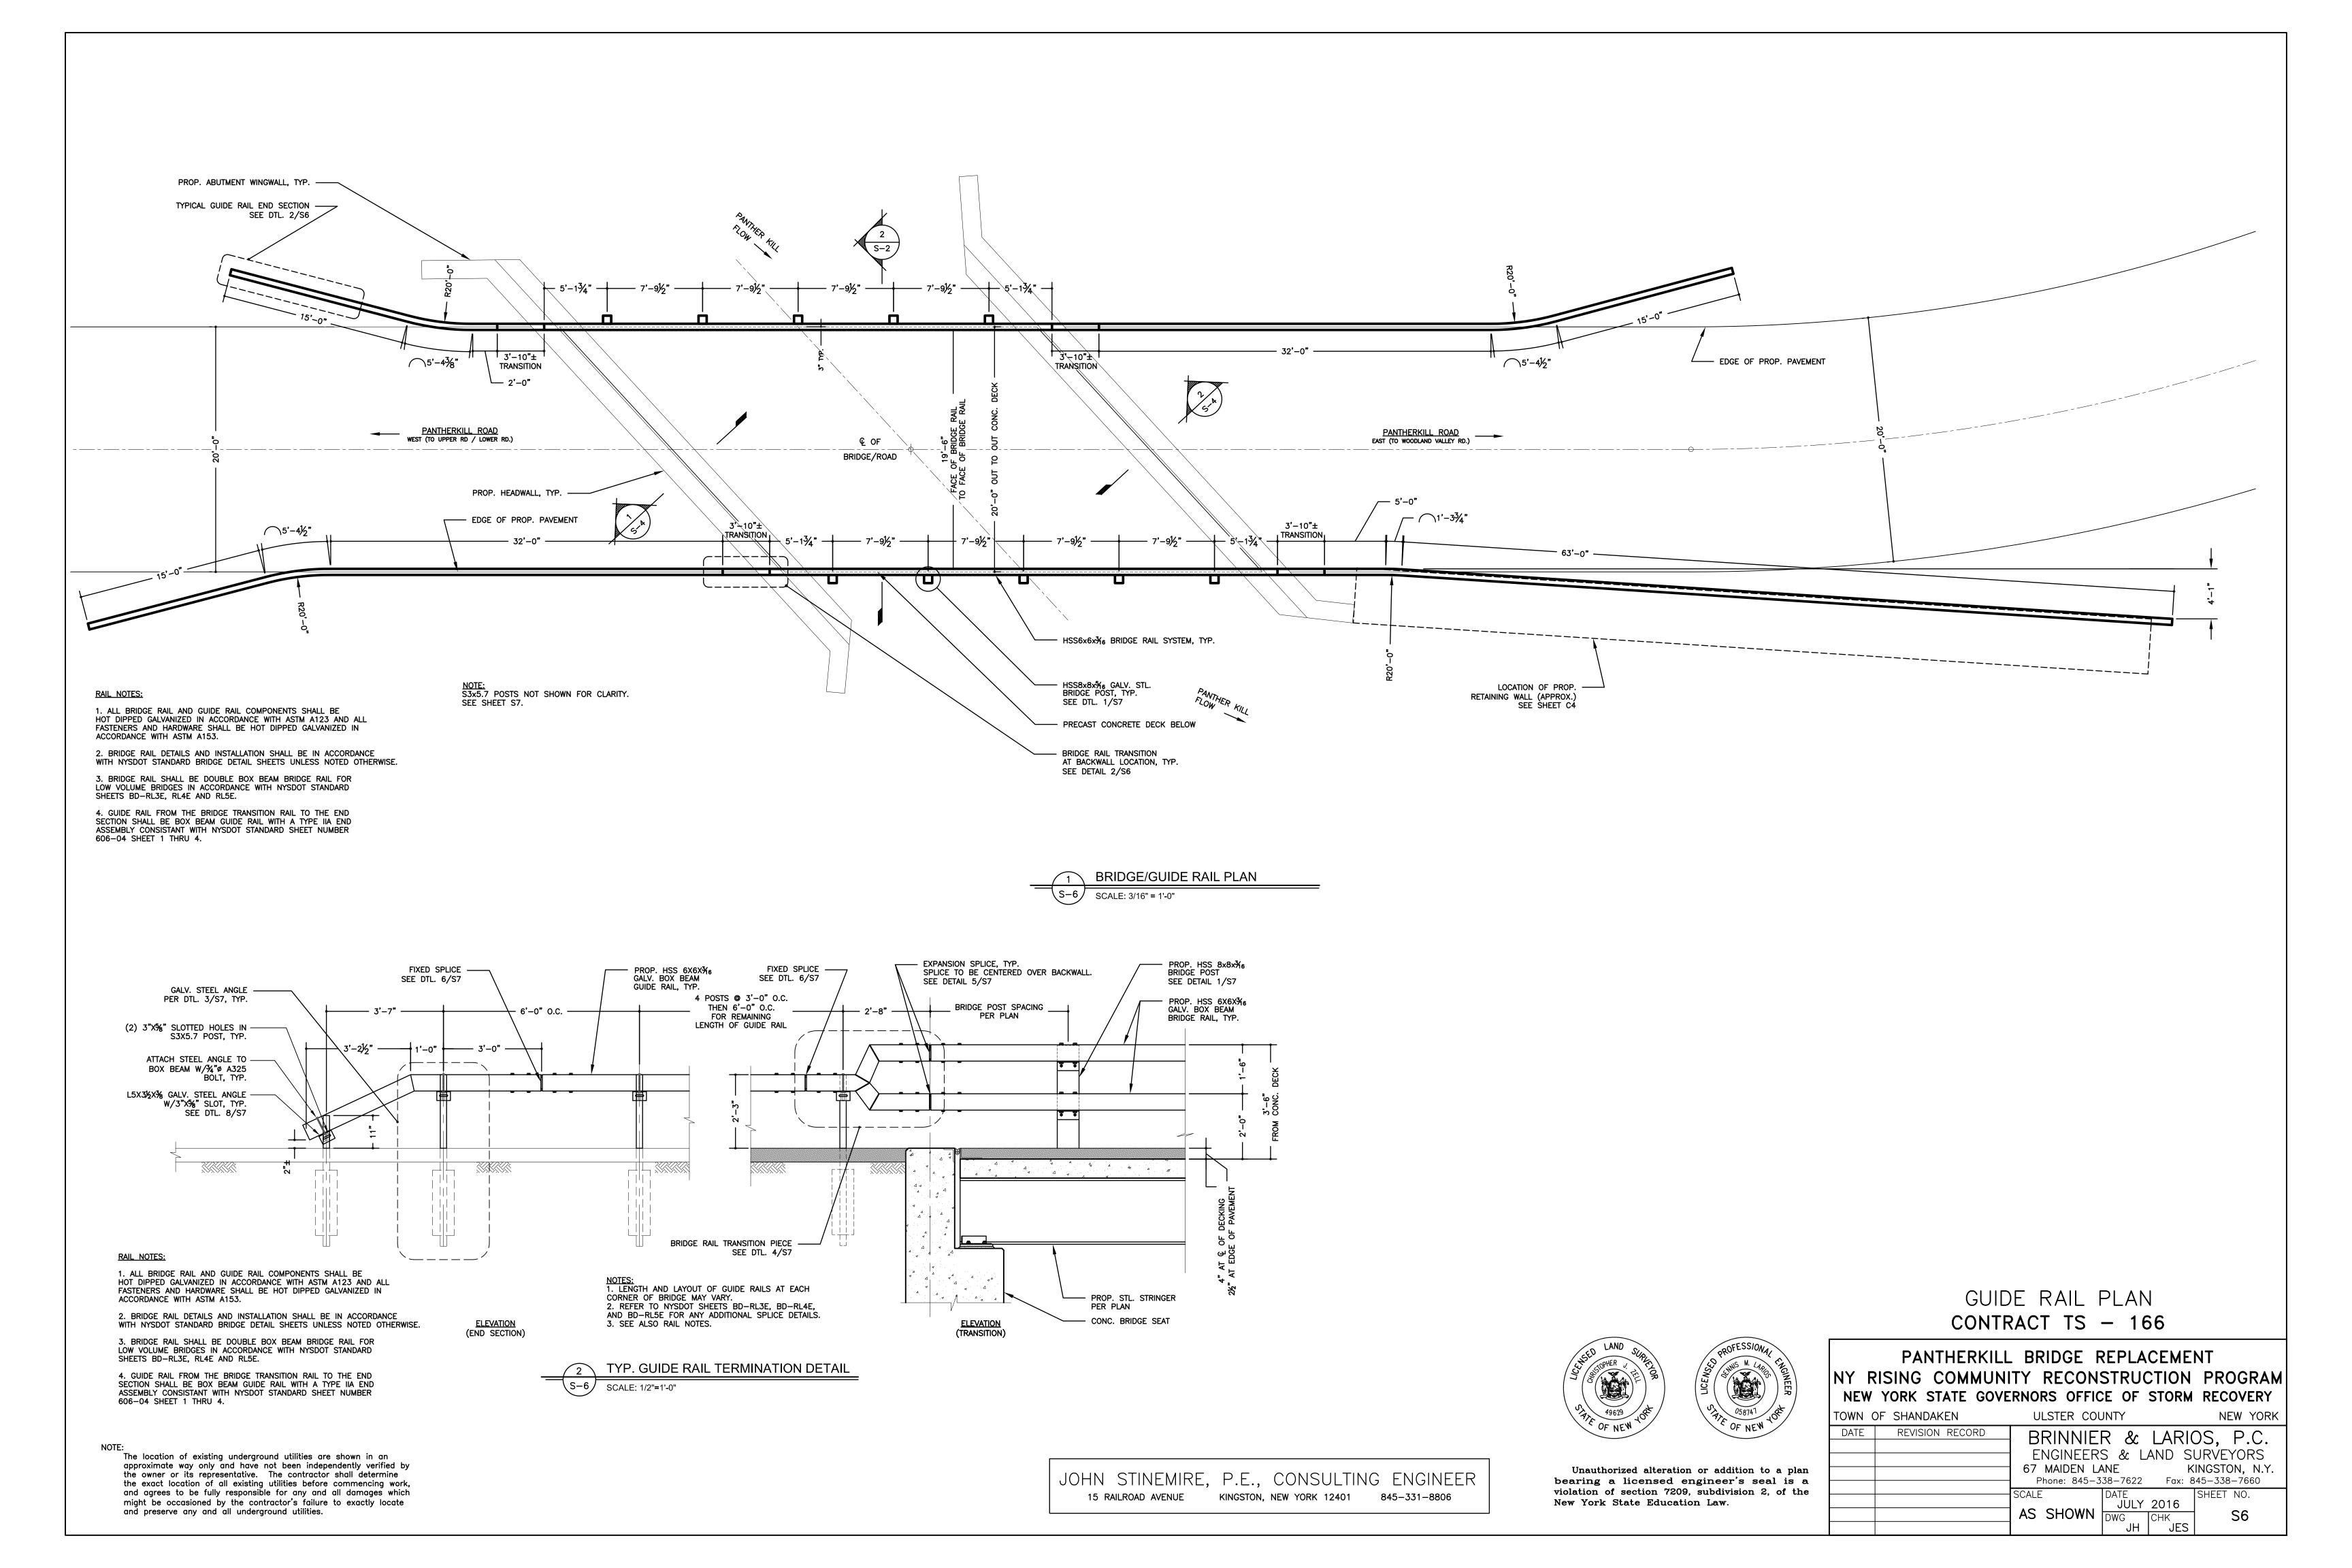

· © OF ¹⁵/₆"Ø HOLES IN TOP AND BOTTOM OF

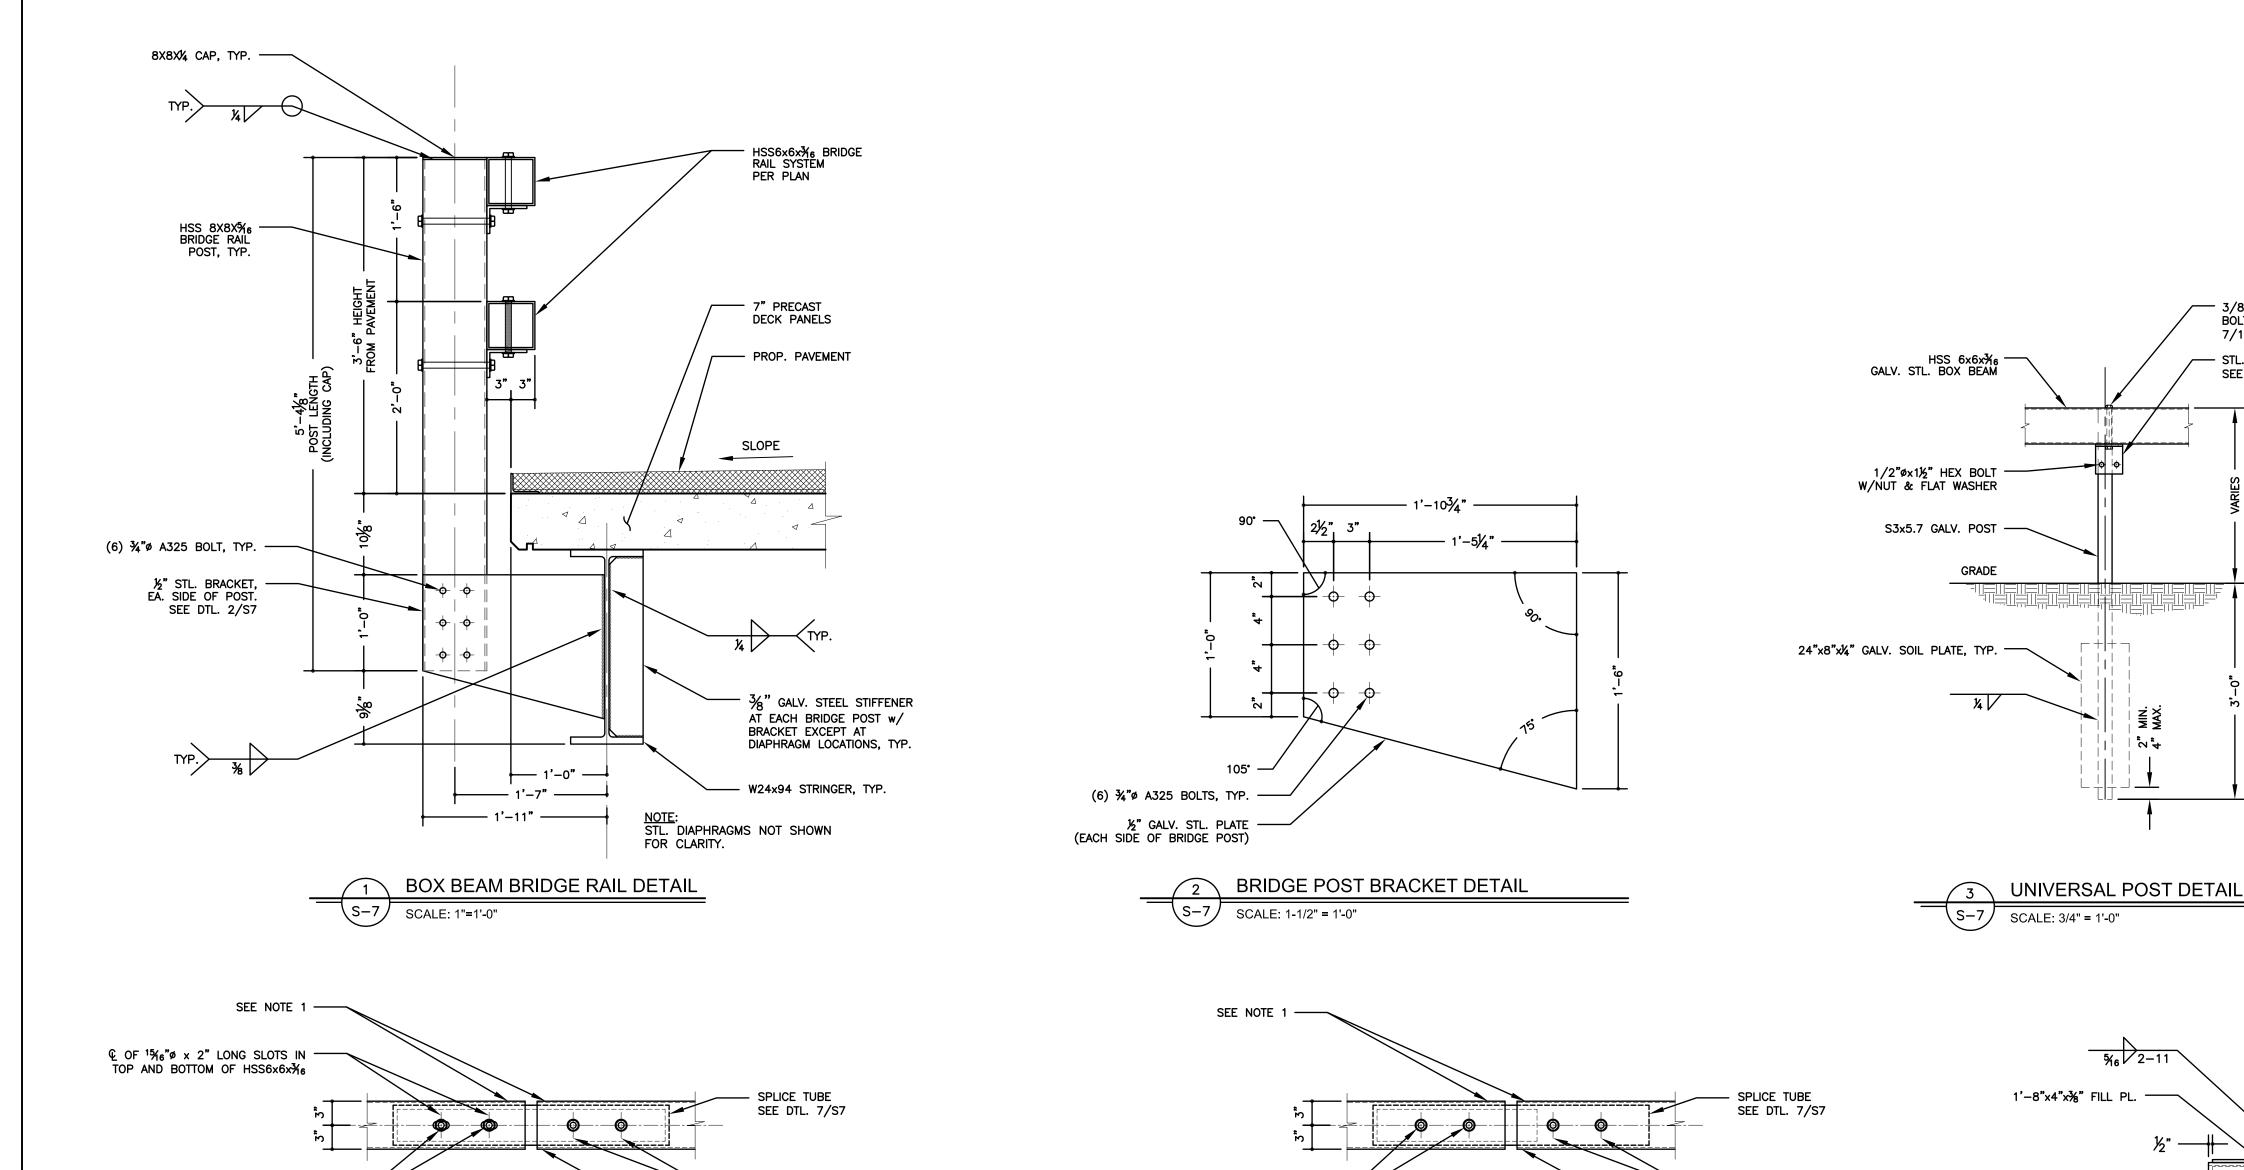HSS6x6x¾6

— TRAFFIC SIDE

- SPLICE TUBE

SEE DTL. 7/S7


<u>PLAN</u>

ELEVATION

EXPANSION SPLICE DETAIL


SCALE: 3/4" = 1'-0"


— SET 1½" @ 68°F

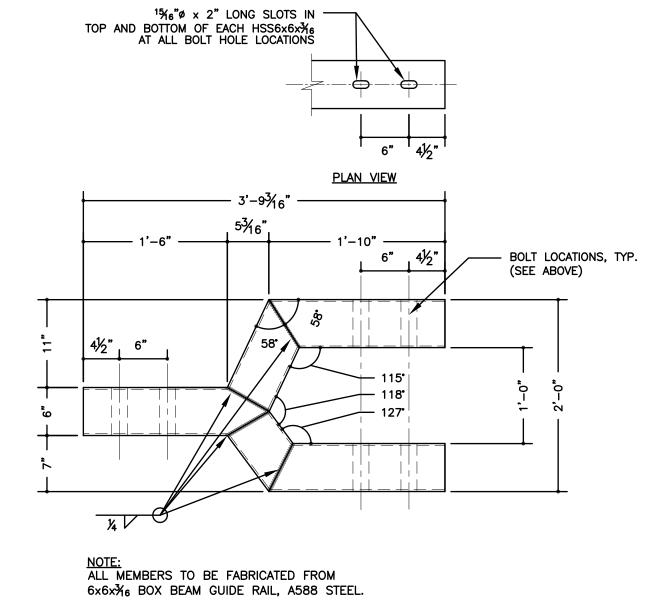

BRIDGE RAIL TRANSITION DETAIL

S-7 SCALE: 1" = 1'-0"

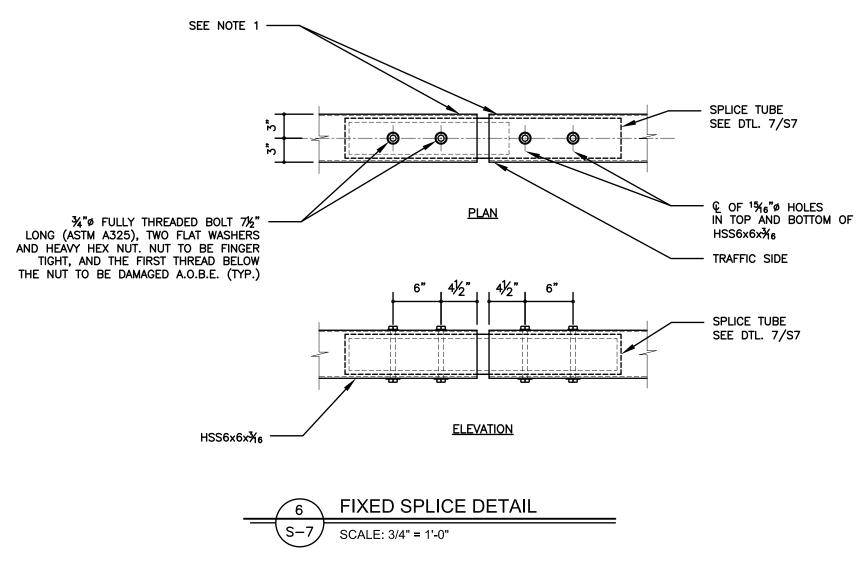

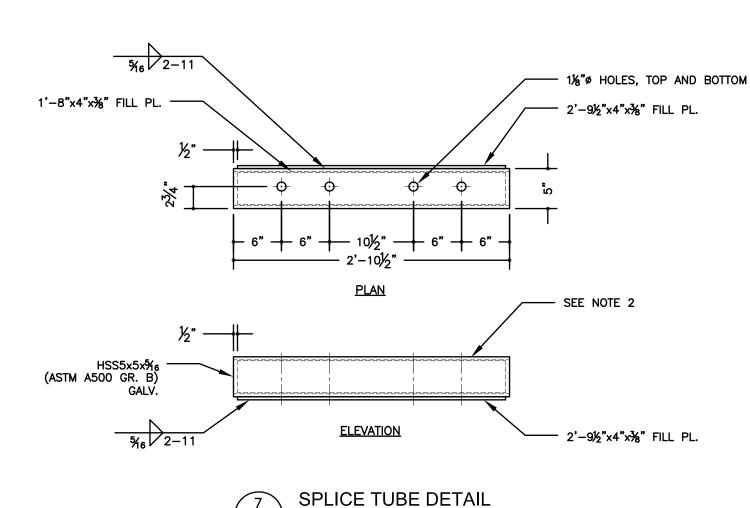


SCALE: 3/4" = 1'-0"

- 3/8"øx7½" LG. (MIN.) BOLT W/NUT & FLAT WASHER.

7/16"ø HOLES

STL. ANGLE BRACKET SEE DETAIL 8/S7

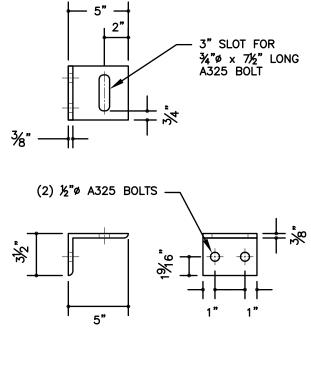

8 GALV. STL. ANGLE BRACKET DETAIL

SCALE: 1-1/2" = 1'-0"

SPLICE DETAIL NOTES:

606-04 SHEET 1 THRU 4.

¾"ø FULLY THREADED BOLT 7½" —

TOP BRIDGE RAIL

HSS6x6x¾6

LONG (ASTM A325), TWO FLAT WASHERS AND HEAVY HEX NUT. NUT TO BE FINGER

THE NUT TO BE DAMAGED A.O.B.E. (TYP.)

TIGHT, AND THE FIRST THREAD BELOW

1. PROTRUSIONS CAUSED BY WELDING OR GALVANIZING ARE NOT PERMITTED ON THE INSIDE WALLS OF THE SPLICE AREA.

2. PROTRUSIONS CAUSED BY WELDING OR GALVANIZING ARE NOT

PERMITTED ON THE OUTSIDE WALLS OF THE SPLICE TUBE AND THE OUTSIDE SURFACES OF THE FILL PLATES.

3. BRIDGE RAIL SHALL BE DOUBLE BOX BEAM BRIDGE RAIL FOR LOW VOLUME BRIDGES IN ACCORDANCE WITH NYSDOT STANDARD SHEETS BD—RL3E, RL4E AND RL5E.

4. GUIDE RAIL FROM THE BRIDGE TRANSITION RAIL TO THE END SECTION SHALL BE BOX BEAM GUIDE RAIL WITH A TYPE IIA END ASSEMBLY CONSISTANT WITH NYSDOT STANDARD SHEET NUMBER

NOTE:

The location of existing underground utilities are shown in an approximate way only and have not been independently verified by the owner or its representative. The contractor shall determine the exact location of all existing utilities before commencing work, and agrees to be fully responsible for any and all damages which might be occasioned by the contractor's failure to exactly locate and preserve any and all underground utilities.


SED LAND SURIER OF NEW 19629




Unauthorized alteration or addition to a plan bearing a licensed engineer's seal is a violation of section 7209, subdivision 2, of the New York State Education Law. GUIDE RAIL DETAILS CONTRACT TS - 166

PANTHERKILL BRIDGE REPLACEMENT NY RISING COMMUNITY RECONSTRUCTION PROGRAM NEW YORK STATE GOVERNORS OFFICE OF STORM RECOVERY

JOHN STINEMIRE, P.E., CONSULTING ENGINEER
15 RAILROAD AVENUE KINGSTON, NEW YORK 12401 845-331-8806

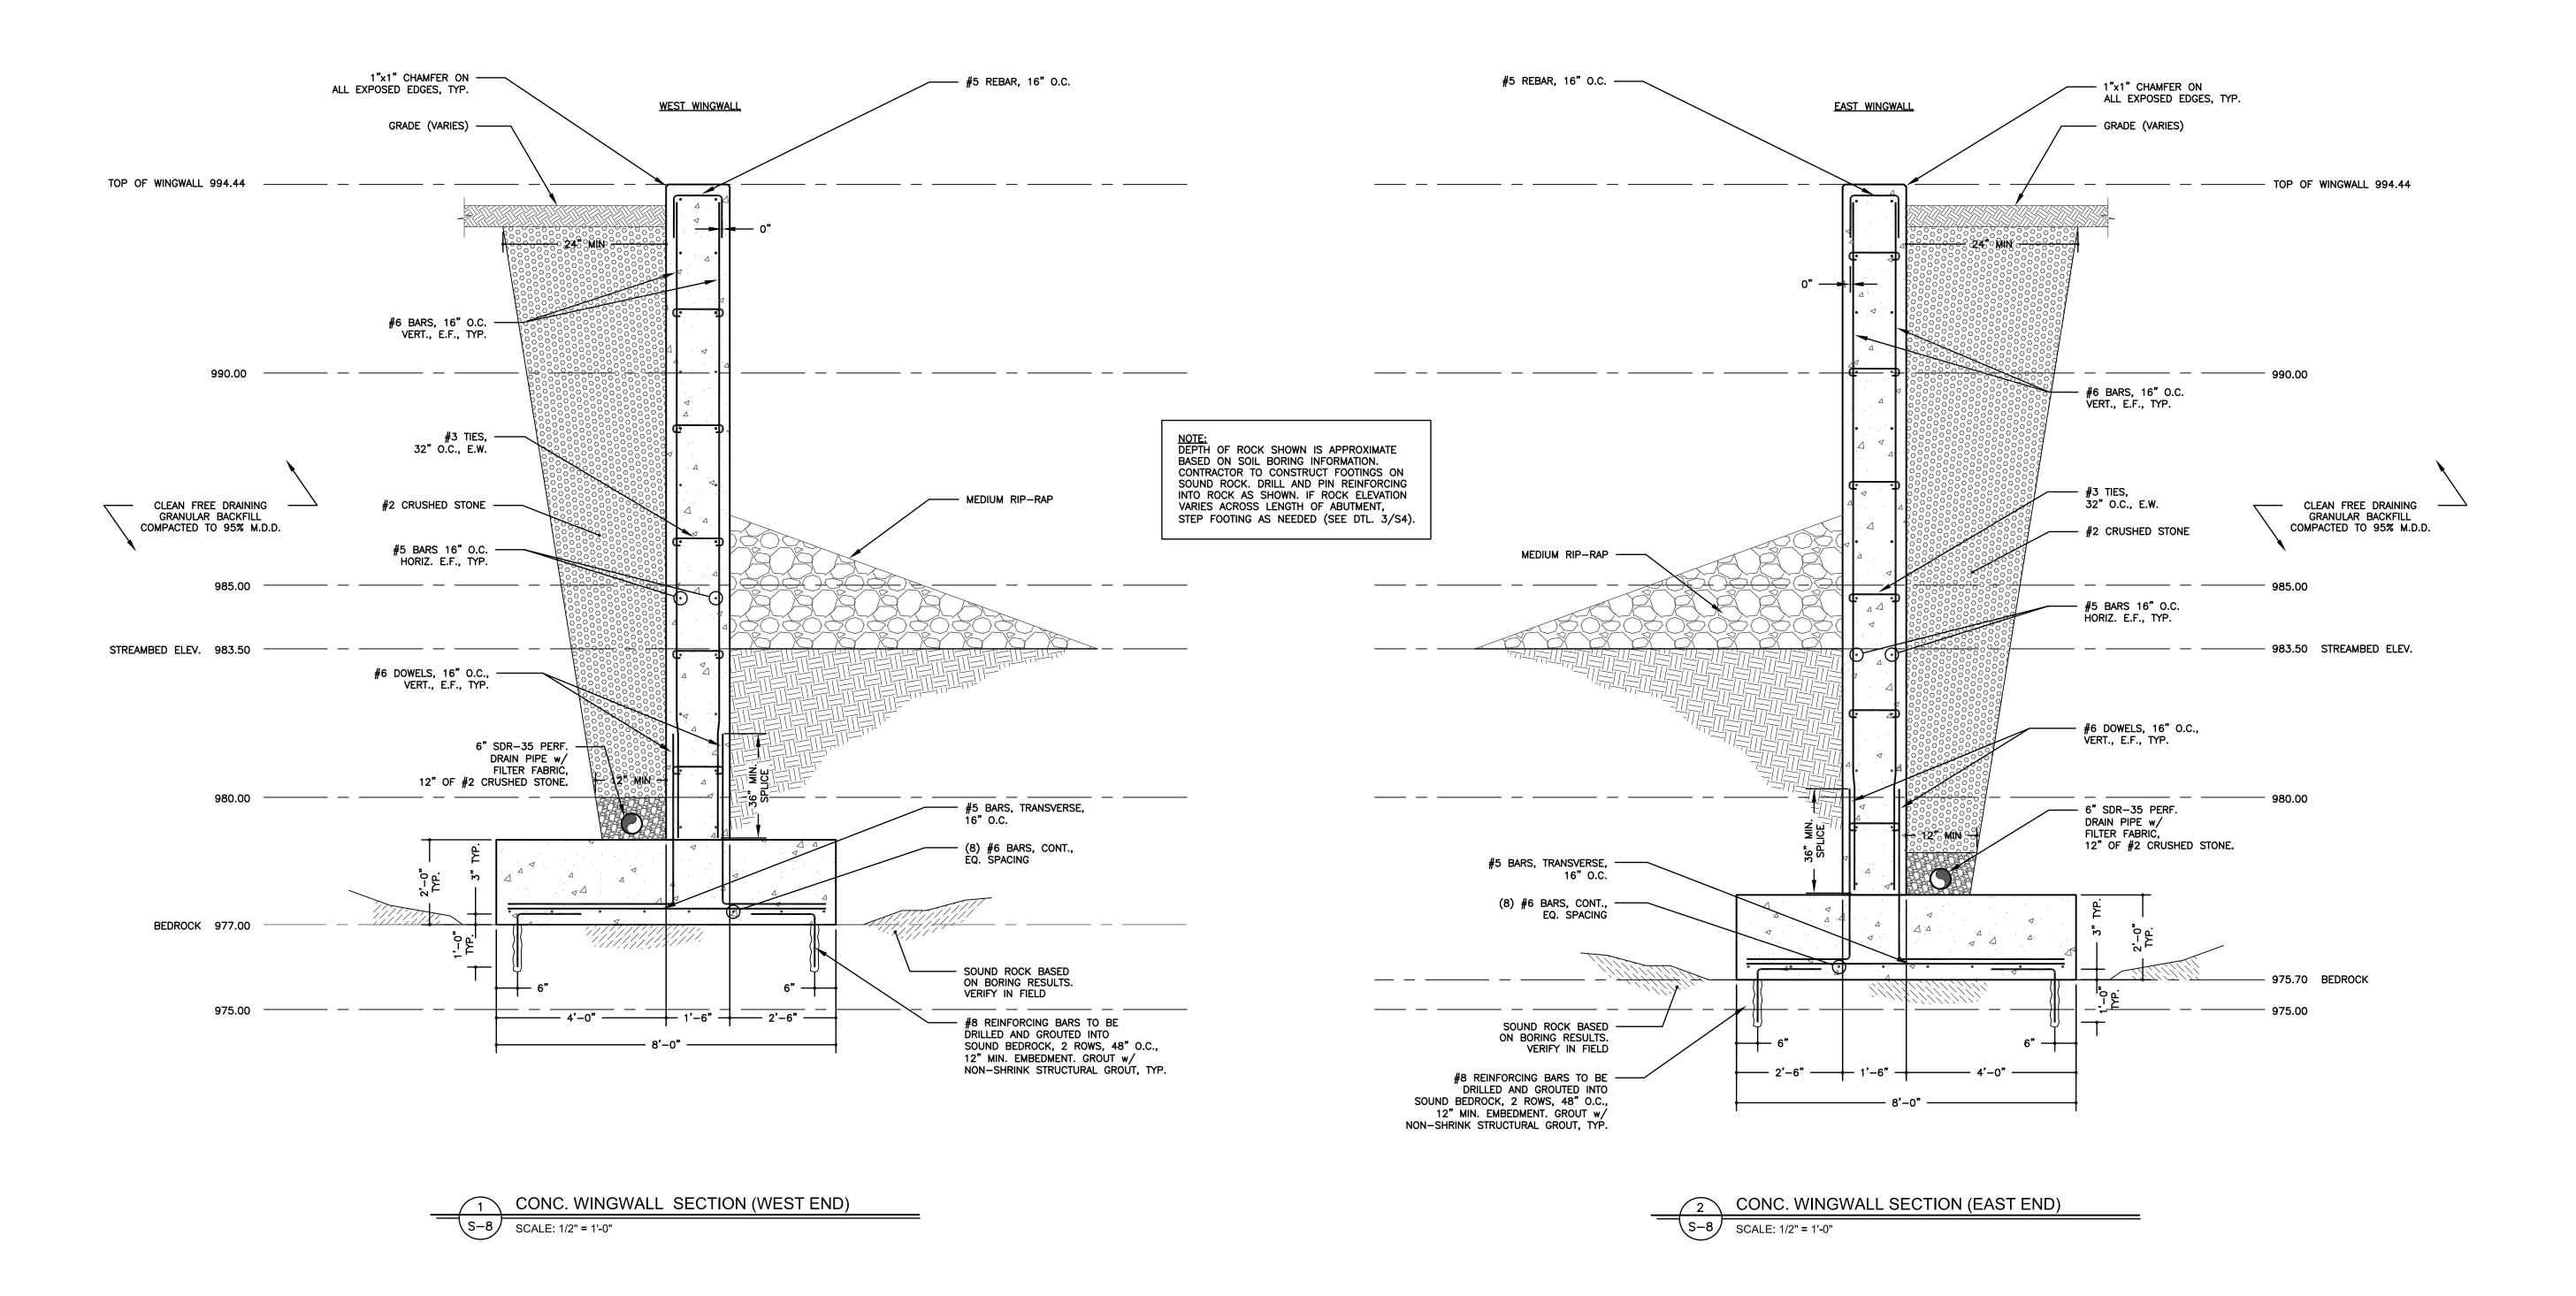

SECTIONS & DETAILS CONTRACT TS - 166

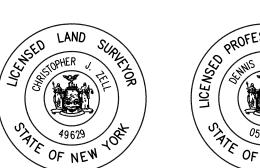

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TOWN OF SHANDAKEN ULSTER COUNTY NEW YORK DATE REVISION RECORD BRINNIER & LARIOS, P.C. ENGINEERS & LAND SURVEYORS 67 MAIDEN LANE KINGSTON, N.Y. Phone: 845-338-7622 Fax: 845-338-7660 SHEET NO. JULY 2016 AS SHOWN DWG CHK JH

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